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Birmingham, Alabama  
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Huntsville, Alabama  
Tampa Bay, Florida  
[www.lbyd.com](http://www.lbyd.com)

LBYD Project Number  
**302-10-002A**

**LBYD, Inc.**  
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9/15/2011


HUNTSVILLE  
The Star of Alabama

**DRAINAGE PLAN**  
**REDSTONE GATEWAY - PACKAGE 1F**  
**ROADWAY IMPROVEMENTS**  
**CITY OF HUNTSVILLE, ALABAMA**

REF.	DATE	BURIN	CHECKED	DESCRIPTION	TRAC	REAL	PE	DRAINE	CON	REVIEW
BSJ		RAN		SEPTEMBER 15, 2011						


**C9.5**  
50 OF 119

0 25 50 100  
SCALE 1" = 50'

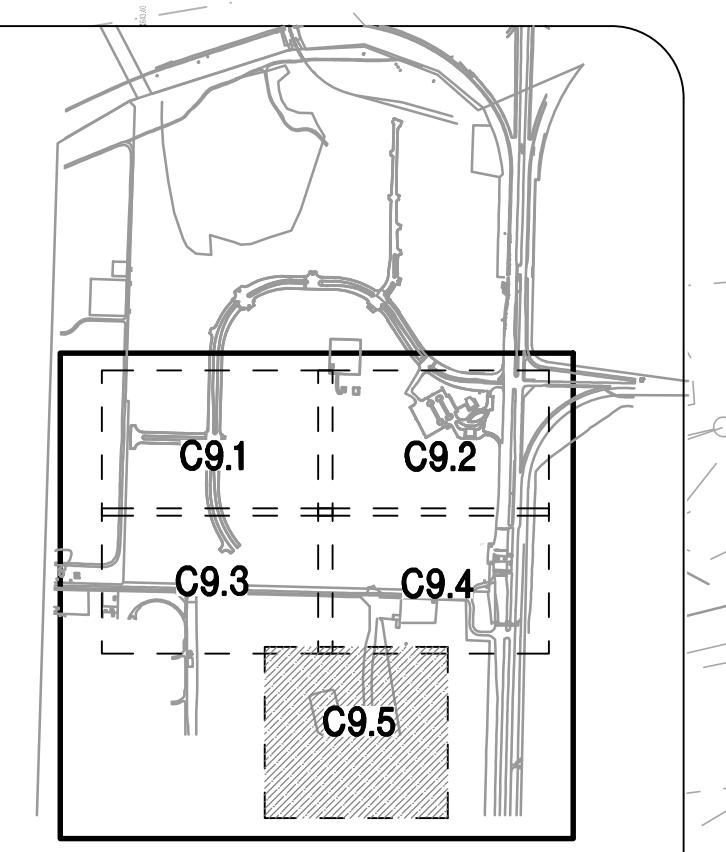

**SITE KEY MAP**  
N.T.S.

1. SEE SHEET C1.0 FOR APPLICABLE PROJECT GENERAL NOTES.  
2. SEE SHEETS C4.0 THRU C4.6 FOR DETAILED LAYOUT INFORMATION.  
3. SEE SHEETS C5.0 THRU C5.6 FOR DETAILED STRIPING AND SIGNAGE INFORMATION.  
4. SEE SHEETS C7.0 TO C7.5 FOR ROADWAY PLAN AND PROFILES.  
5. SEE SHEETS C8.0 TO C8.5 FOR DETAILED GRADING INFORMATION.  
6. SEE SHEET C9.5 TO 9.10 FOR STORM PROFILE INFORMATION.  
7. SEE SHEETS C13.0 TO C13.14 FOR ROADWAY CROSS SECTIONS.

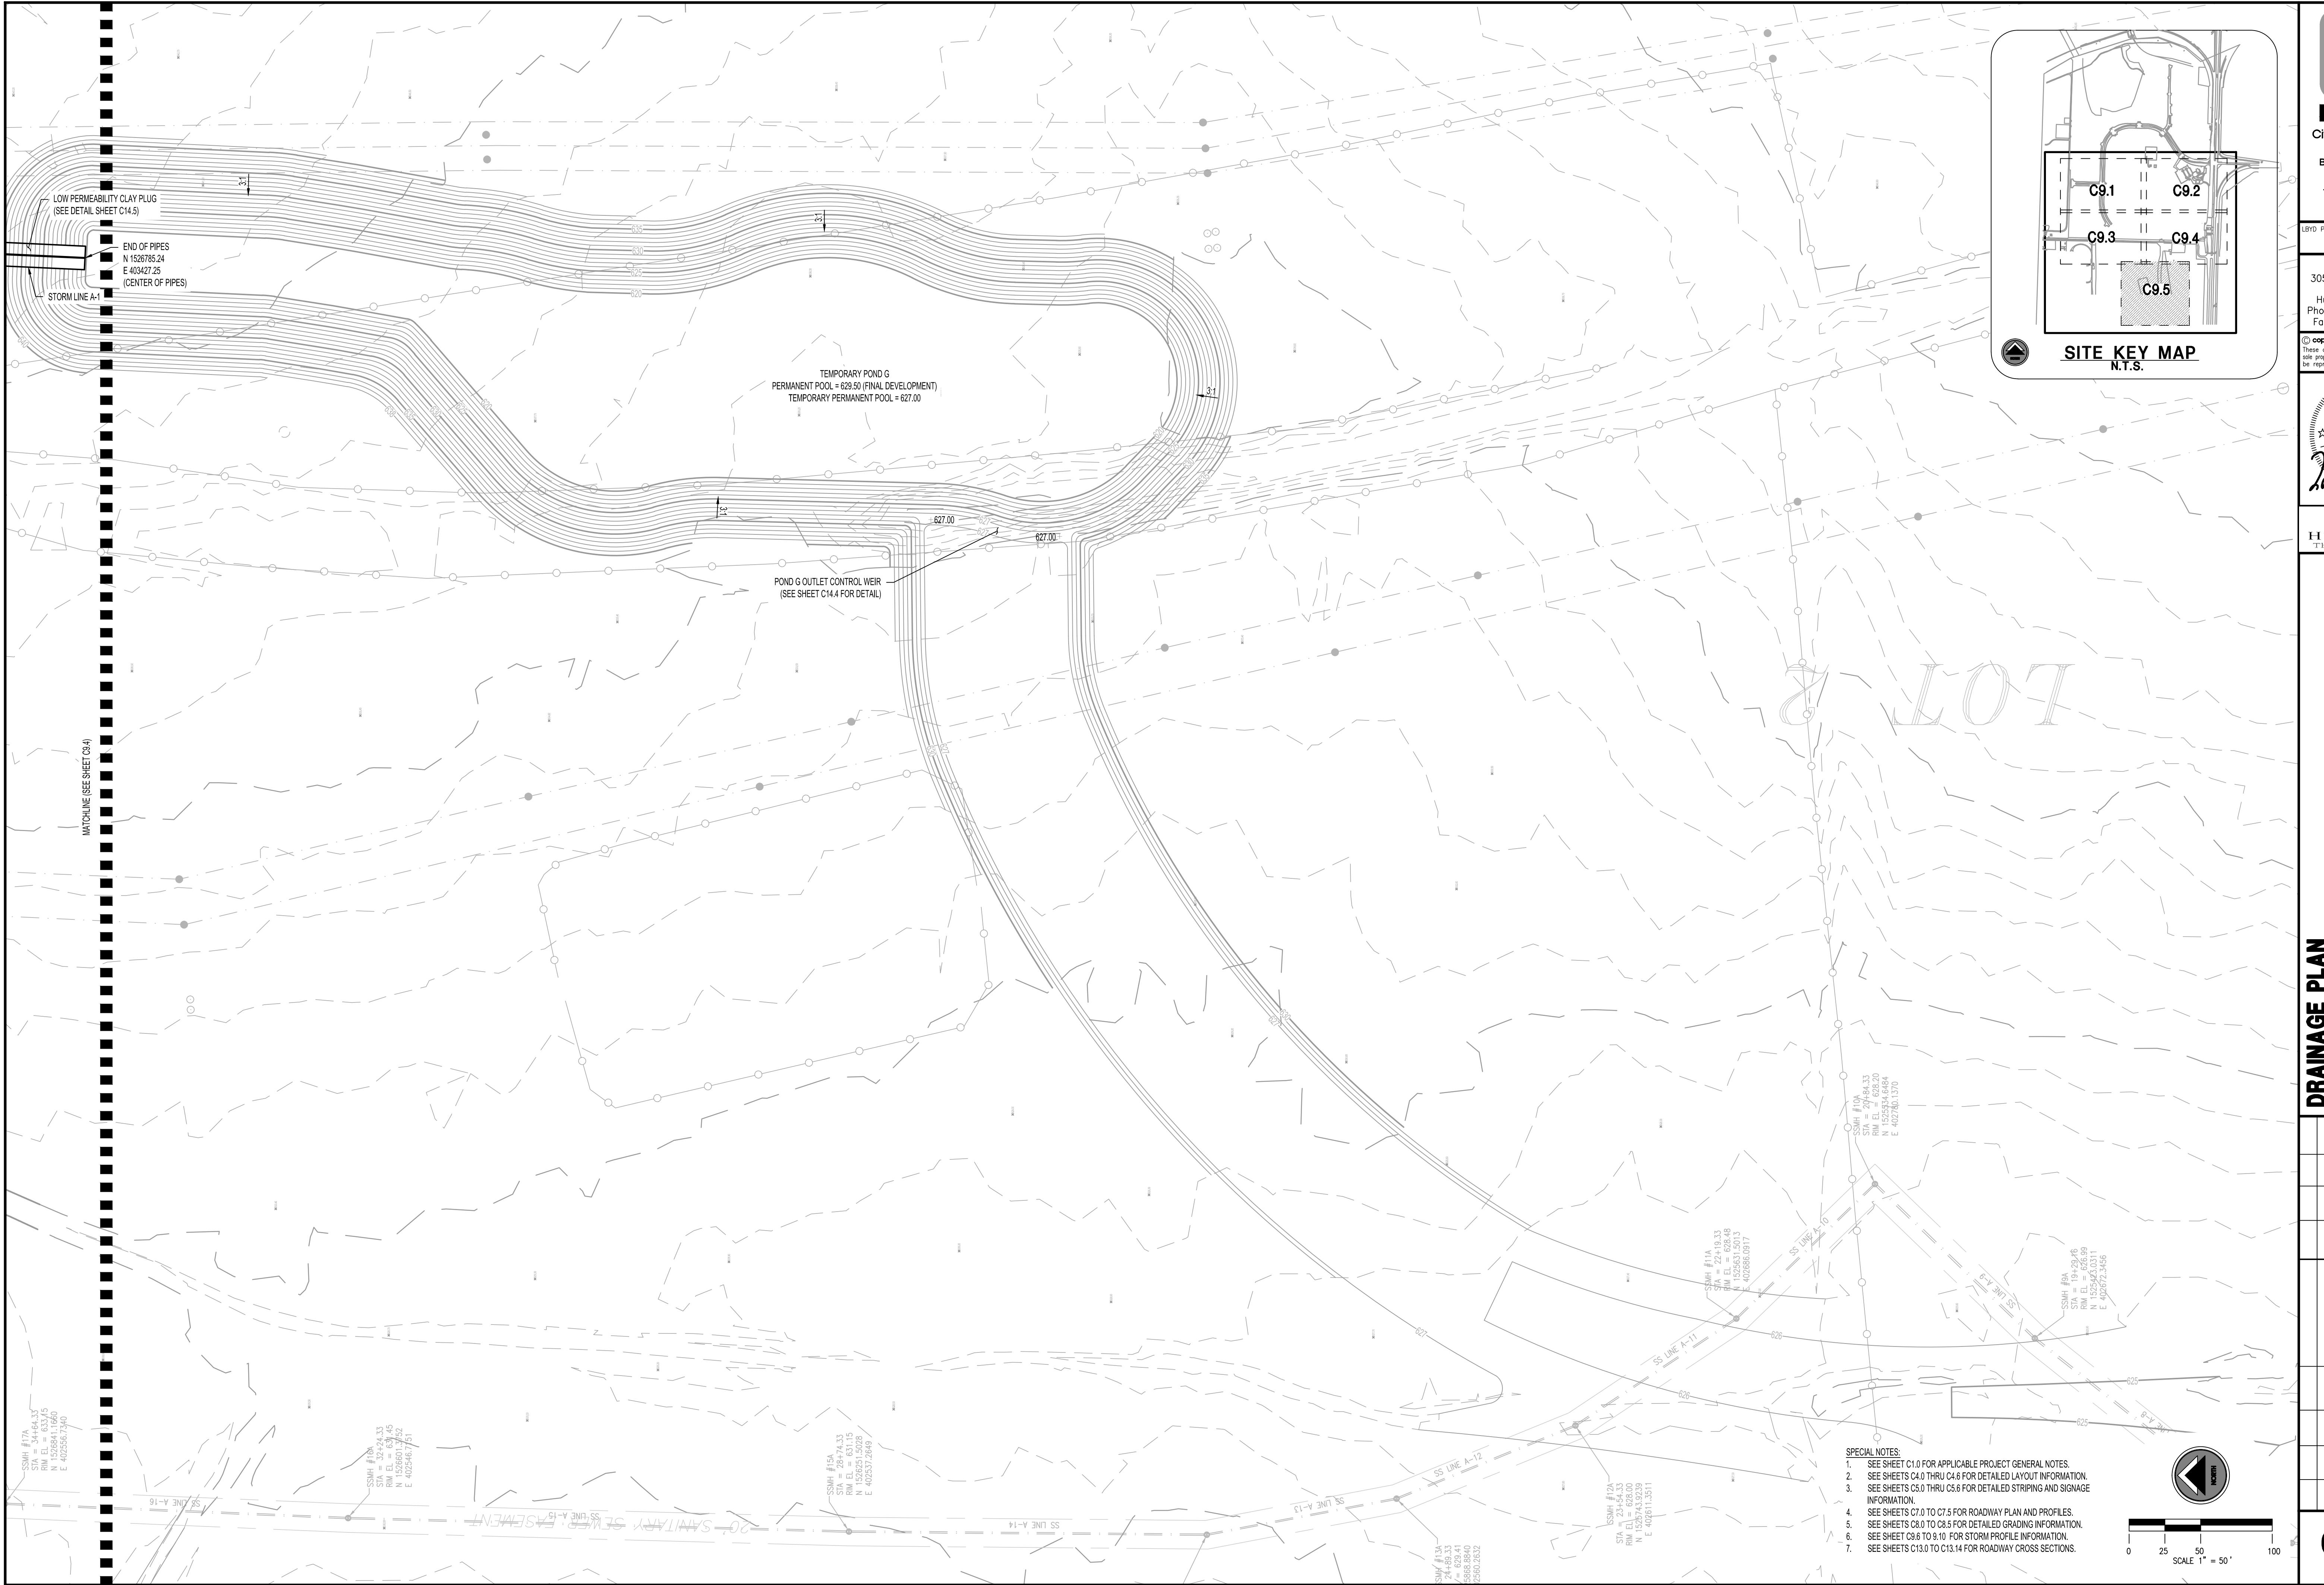



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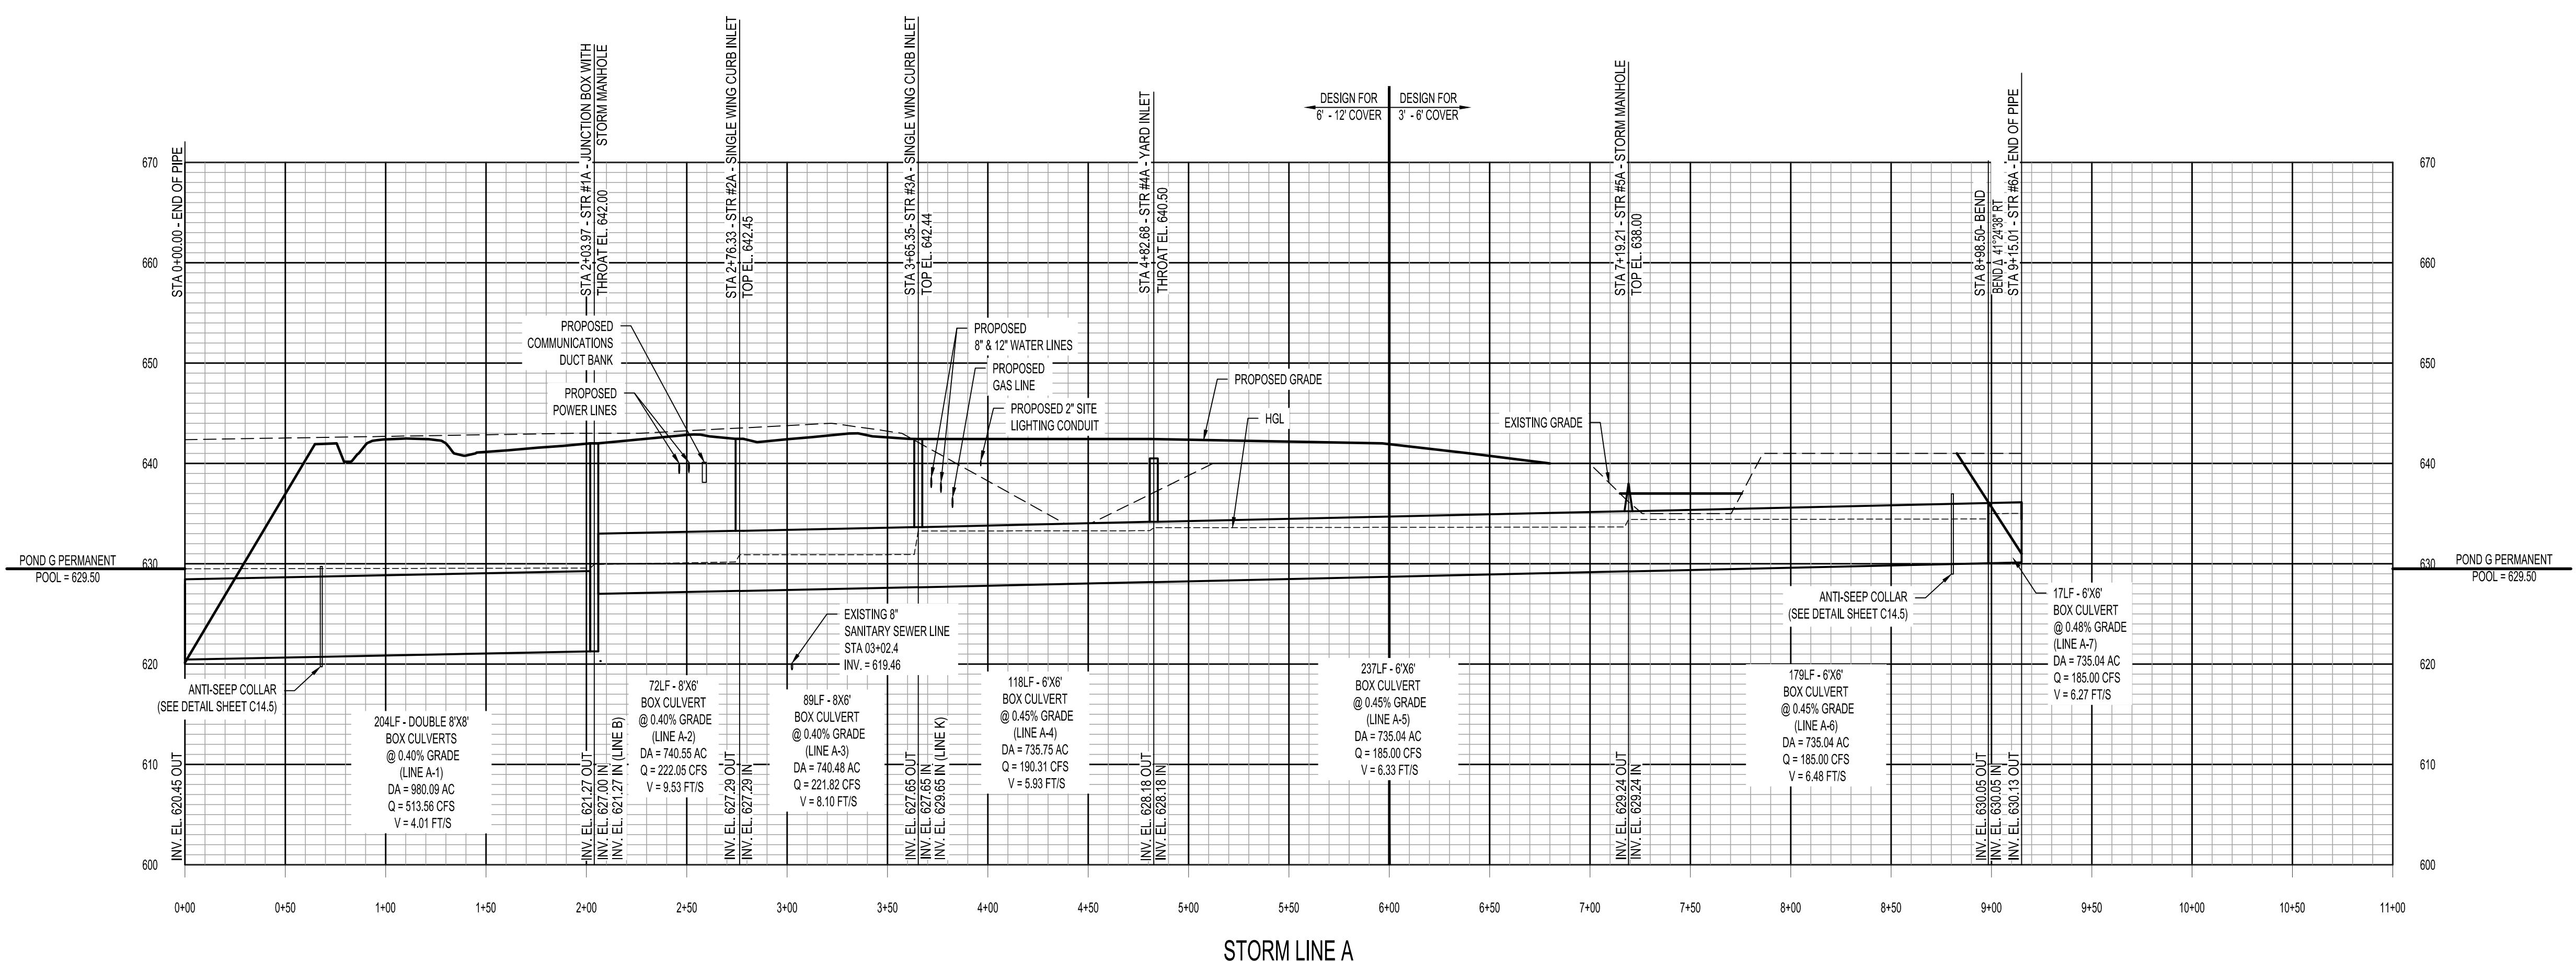
3/15/2011

## STORM PROFILES


### REDSTONE GATEWAY - PACKAGE 1F

#### ROADWAY IMPROVEMENTS

#### CITY OF HUNTSVILLE, ALABAMA



STORM LINE A

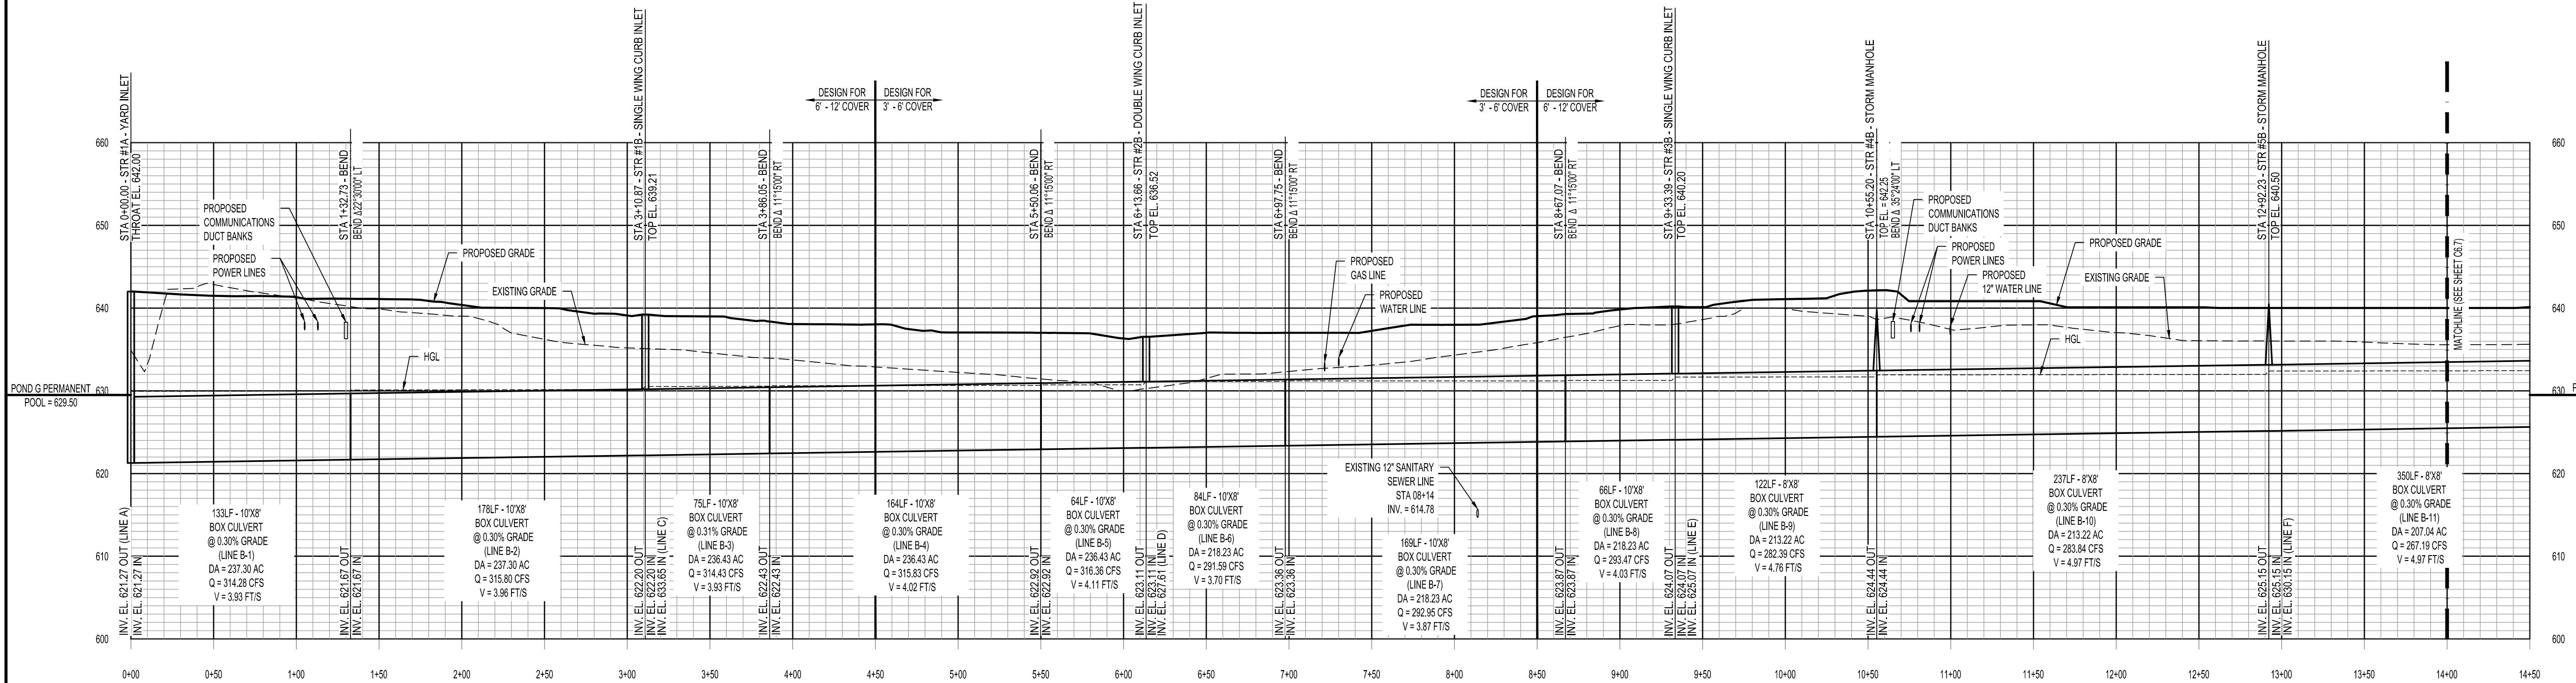

STORM LINE B

LineID	FlowRate (cfs)	LineSize (in)	LineType	InvertDn (ft)	InvertUp (ft)	HGLDn (ft)	HGLUp (ft)	LineSlope (%)	VelAve (ft/s)
Line A-1	513.56	96 x 96(2b)	Box	620.45	621.27	629.50	629.57	0.40	4.01
Line A-2	222.05	72 x 72	Box	627.00	627.29	629.94	630.18	0.40	9.53
Line A-3	221.82	72 x 96	Box	627.29	627.85	630.90	630.91	0.40	8.10
Line A-4	190.31	72 x 72	Box	627.65	628.18	633.26	633.29	0.45	5.93
Line A-5	185.00	72 x 72	Box	628.18	628.24	633.59	633.66	0.45	6.33
Line A-6	185.00	72 x 72	Box	629.24	630.05	634.41	634.46	0.45	6.48
Line A-7	185.00	72 x 72	Box	630.05	630.13	635.00	635.01	0.48	6.27
Line B-1	314.28	96 x 120	Box	621.27	621.67	629.94	629.99	0.30	3.93
Line B-2	315.80	96 x 120	Box	621.67	622.20	630.10	630.16	0.30	3.96
Line B-3	314.43	96 x 120	Box	622.20	622.43	630.52	630.55	0.31	3.93
Line B-4	315.83	96 x 120	Box	622.43	622.92	630.61	630.65	0.30	4.02
Line B-5	316.36	96 x 120	Box	622.92	623.11	630.71	630.72	0.30	4.11
Line B-6	291.59	96 x 120	Box	623.11	623.36	631.12	631.14	0.30	3.70
Line B-7	292.95	96 x 120	Box	623.36	623.87	631.19	631.20	0.30	3.87
Line B-8	293.47	96 x 120	Box	623.87	624.07	631.25	631.26	0.30	4.03
Line B-9	282.39	96 x 96	Box	624.07	624.44	631.65	631.68	0.30	4.76
Line B-10	283.84	96 x 96	Box	624.44	625.15	631.92	631.98	0.30	4.97
Line B-11	267.19	96 x 96	Box	625.15	626.20	632.38	632.48	0.30	4.97

\* POND F PERMANENT POOL ELEVATION = 633.50 (FINAL DEVELOPMENT).  
\*\* POND G PERMANENT POOL ELEVATION = 629.50 (FINAL DEVELOPMENT).



SCALE	1'-50" HORIZONTAL	1'-10" VERTICAL
HGL	EXISTING GRADE	PROPOSED GRADE
STORM SEWER	—	—
SWALE	—	—

**C9.6**  
REV. DATE: DRAWN: CHECKED: DESCRIPTION: RAN: DATE: SEPTEMBER 15, 2011  
DRAWN: BSJ CHECKED: RAN DATE: SEPTEMBER 15, 2011

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**STORM PROFILES**  
**REDSTONE GATEWAY - PACKAGE 1F**  
**ROADWAY IMPROVEMENTS**  
**CITY OF HUNTSVILLE, ALABAMA**



LineID	FlowRate (cfs)	LineSize (in)	LineType	InvertDn (ft)	InvertUp (ft)	HGLdn (ft)	HGLup (ft)	LineSlope (%)	VsAve (ft/s)
Line B-11	267.19	96 x 96	Box	625.15	626.20	632.38	632.48	0.30	4.97
Line B-12	268.76	96 x 96	Box	626.20	627.10	632.54	632.64	0.30	5.68
Line B-13	101.93	48 x 60	Box	629.60	630.05	633.21	633.36	0.30	5.90
Line B-14	79.61	54.00	Cr	630.05	630.47	633.95	634.25	0.20	5.51
Line C	3.21	18.00	Cr	633.65	634.59	634.22	635.27	1.00	4.65
Line D-1	74.34	42.00	Cr	627.61	628.55	631.12	631.24	1.00	8.56
Line D-2	68.08	42.00	Cr	628.55	629.30	632.02	631.83	1.45	8.12
Line E	34.84	36.00	Cr	625.07	625.99	631.65	631.90	1.00	4.93
Line F-1	37.59	36.00	Cr	630.15	630.79	632.38	632.77	0.50	7.14
Line F-2	26.89	30.00	Cr	631.29	632.12	633.22	634.02	0.50	6.67
Line F-3	7.00	18.00	Cr	635.26	636.02	636.05	637.03	1.51	6.48

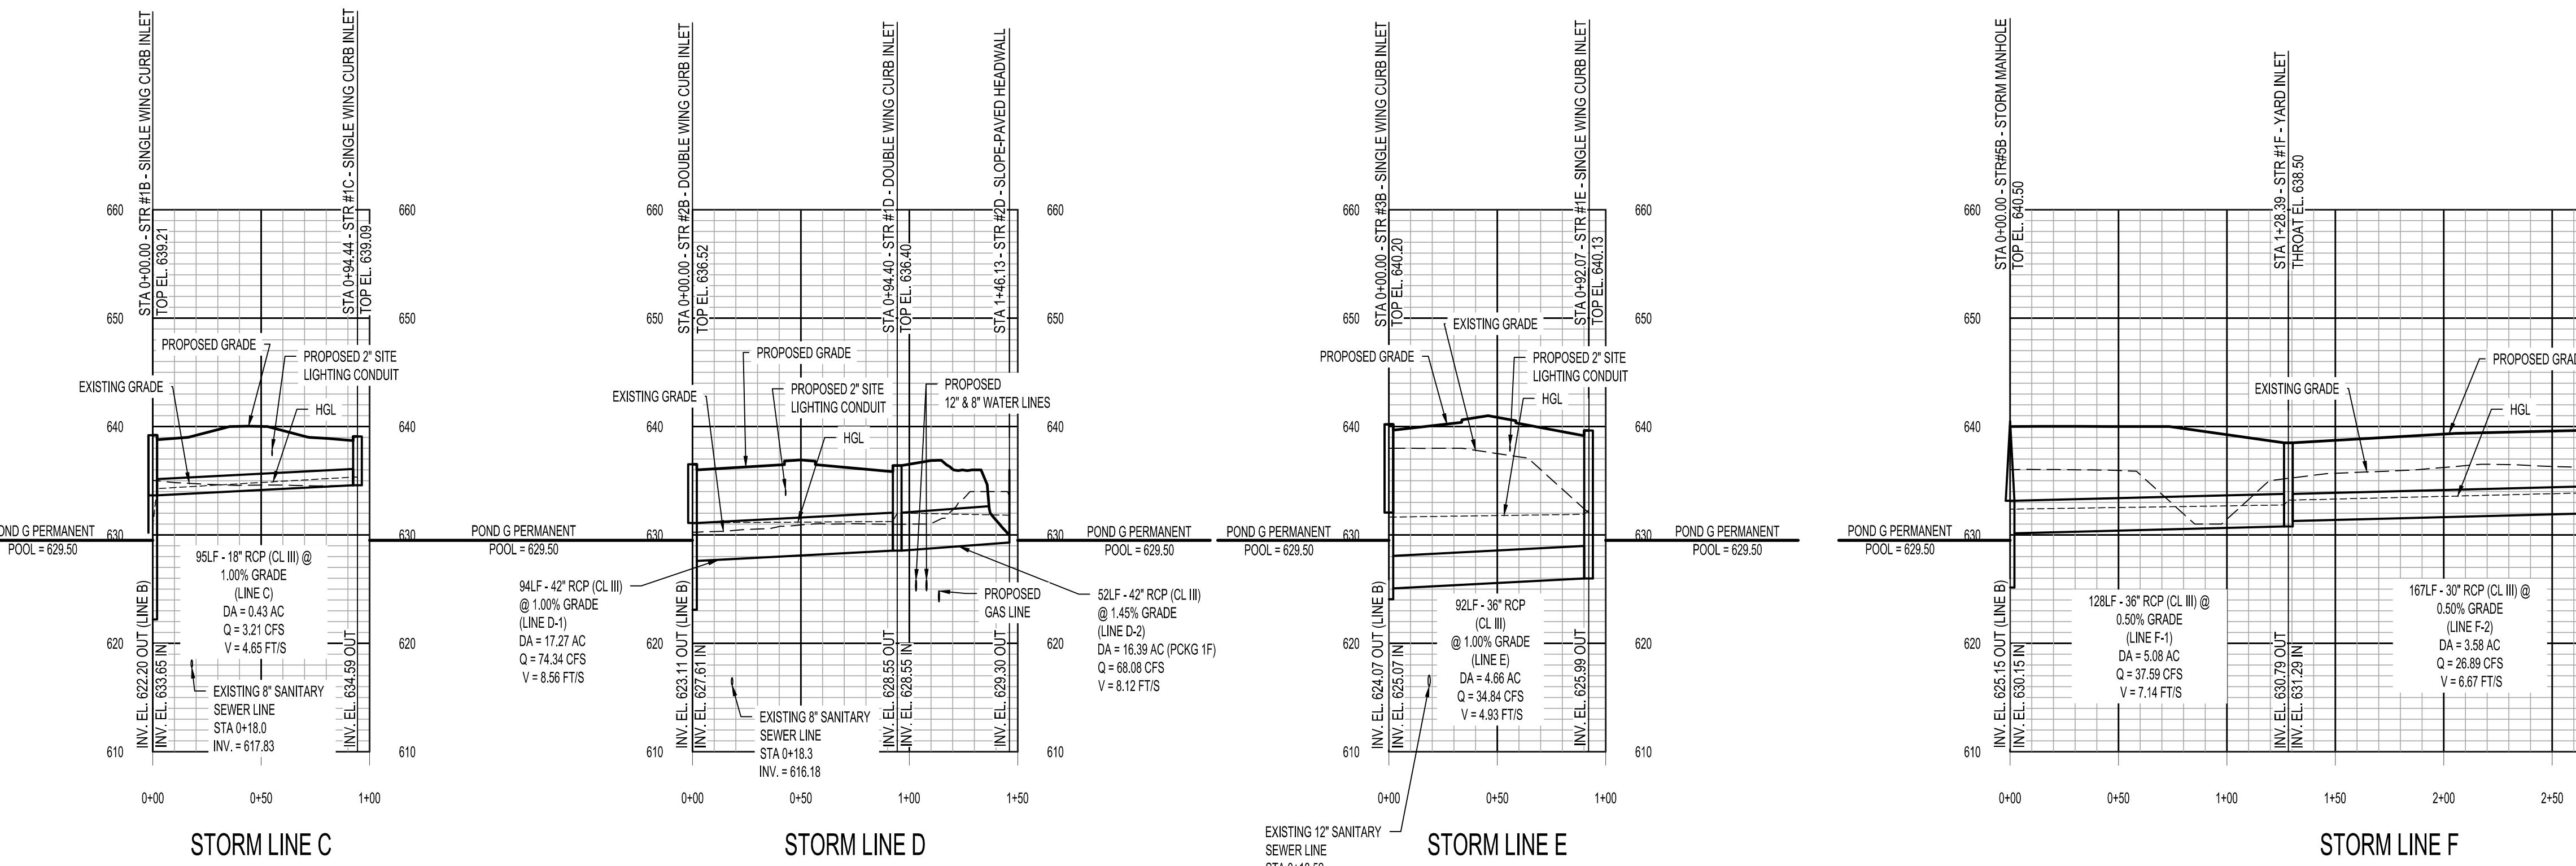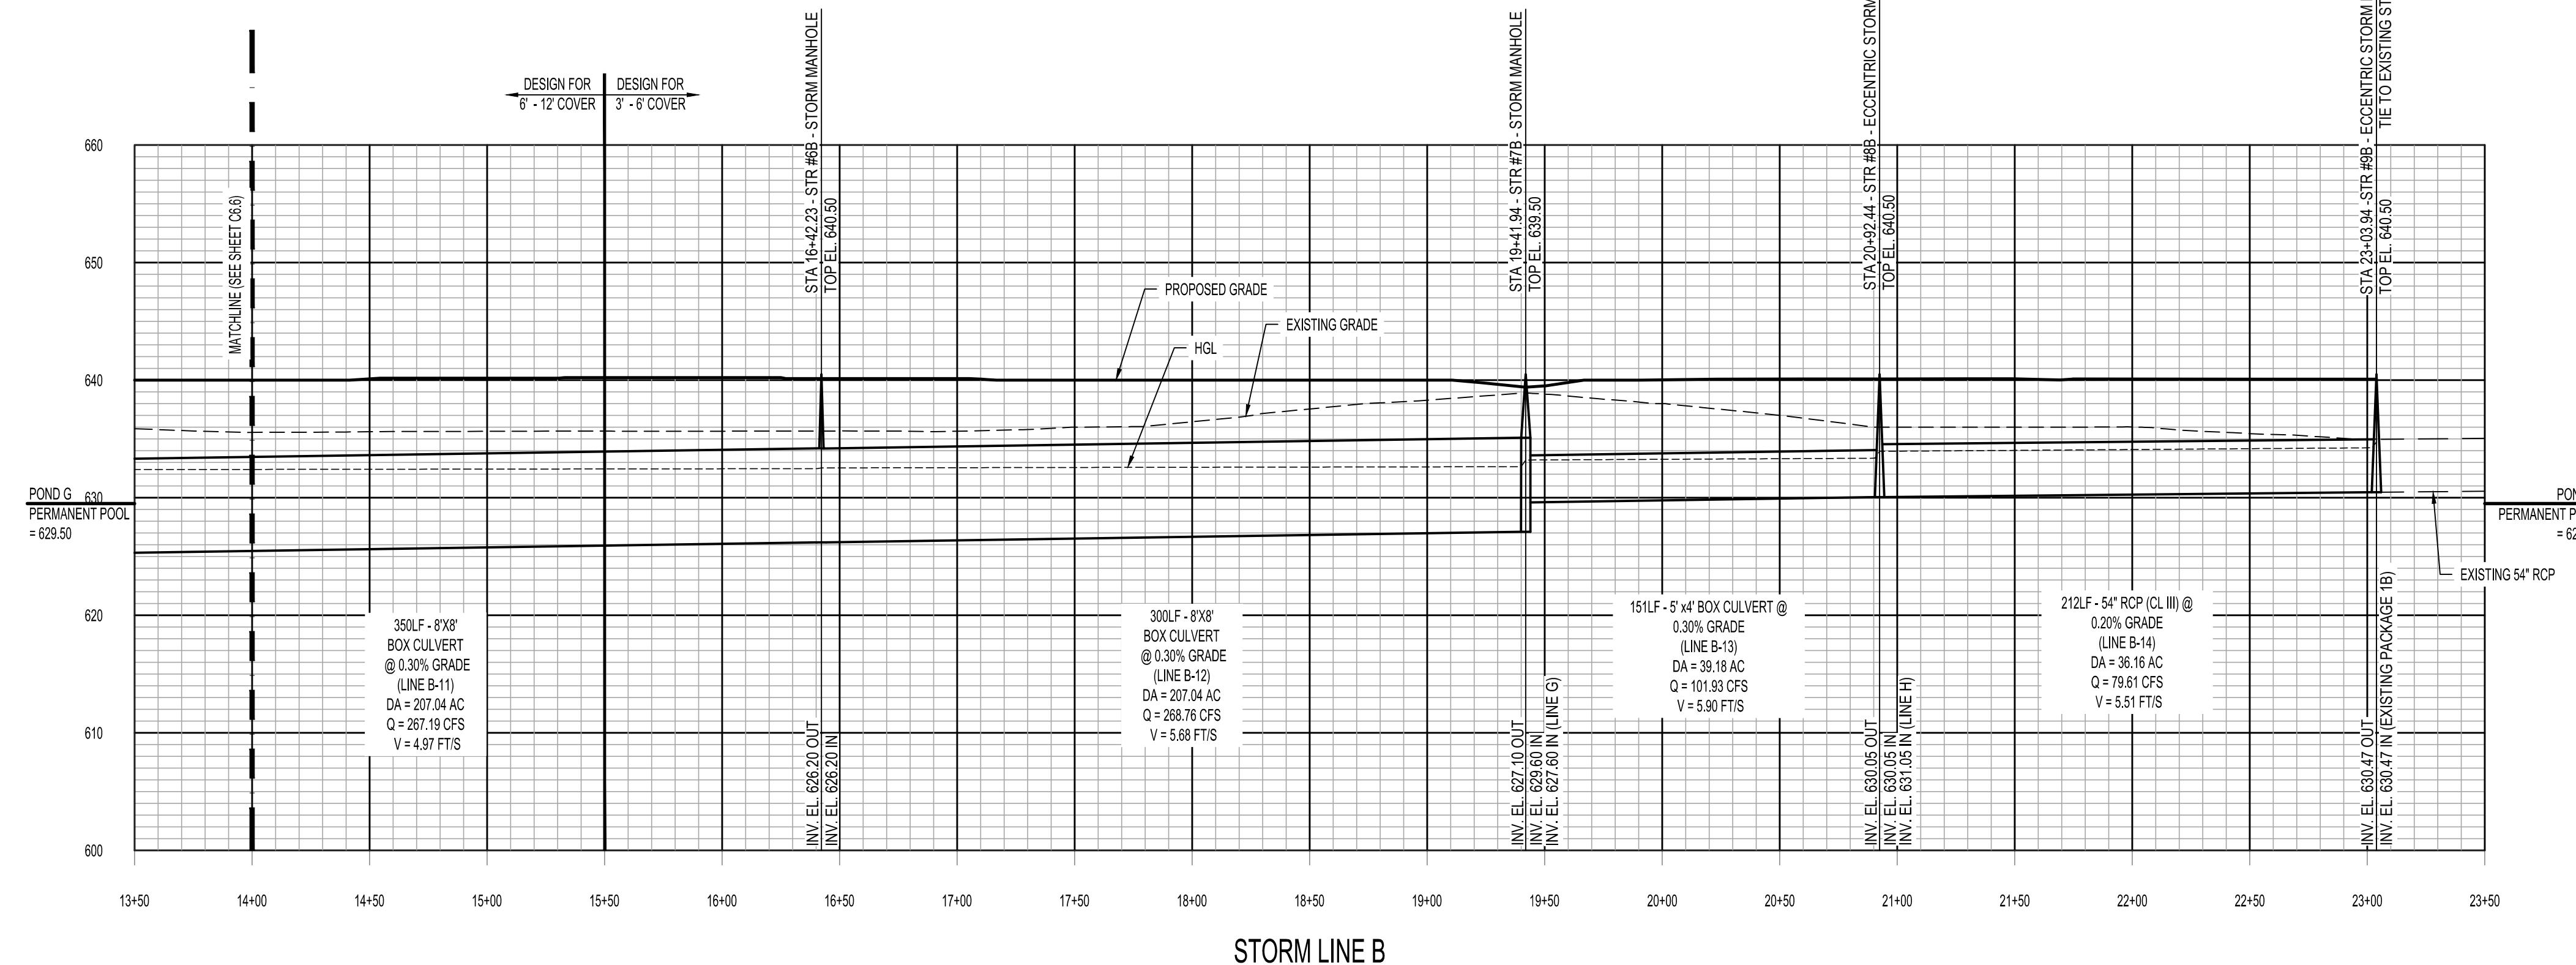\* POND F PERMANENT POOL ELEVATION = 633.50 (FINAL DEVELOPMENT).  
\*\* POND G PERMANENT POOL ELEVATION = 629.50 (FINAL DEVELOPMENT).

SCALE
1"-50' HORIZONTAL
1"-10' VERTICAL
HGL
EXISTING GRADE
PROPOSED GRADE
STORM SEWER




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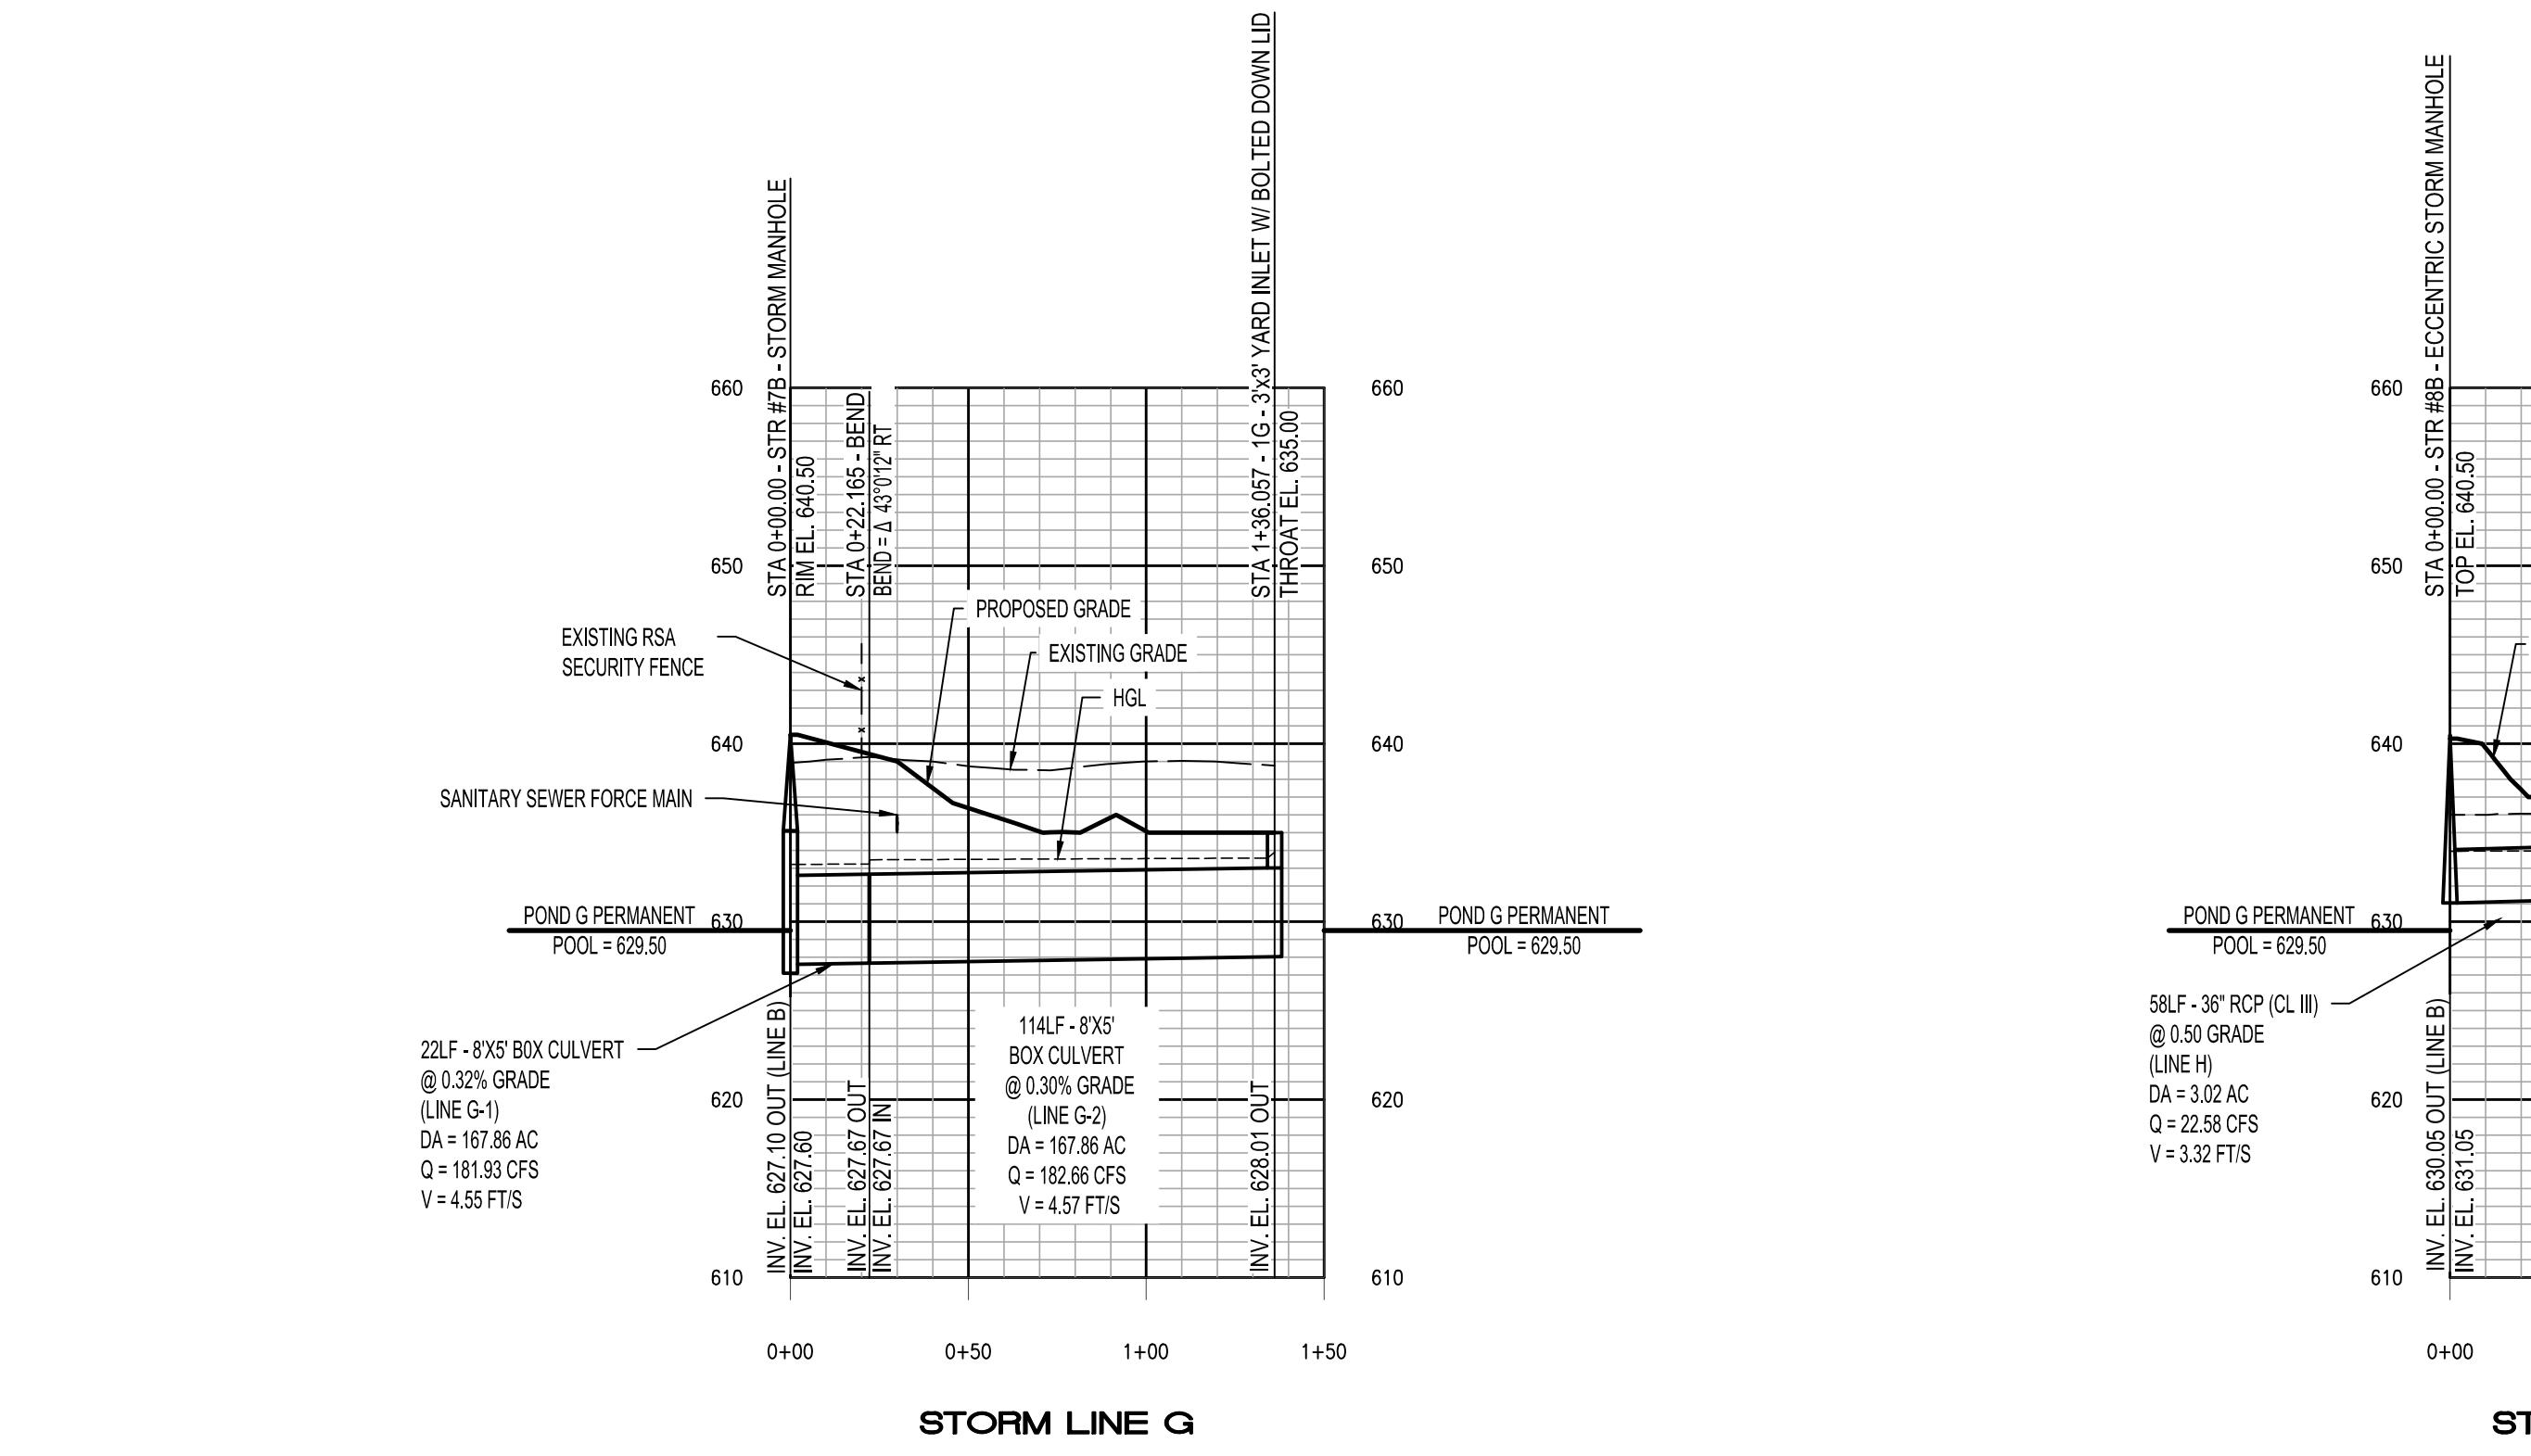
HUNTSVILLE  
The Star of Alabama

## STORM PROFILES


### REDSTONE GATEWAY - PACKAGE 1F

#### ROADWAY IMPROVEMENTS

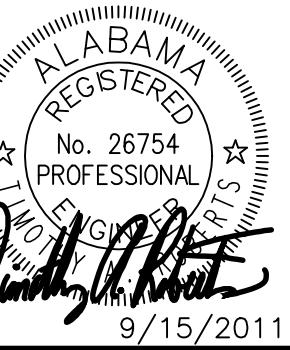
##### CITY OF HUNTSVILLE, ALABAMA




STORM LINE G

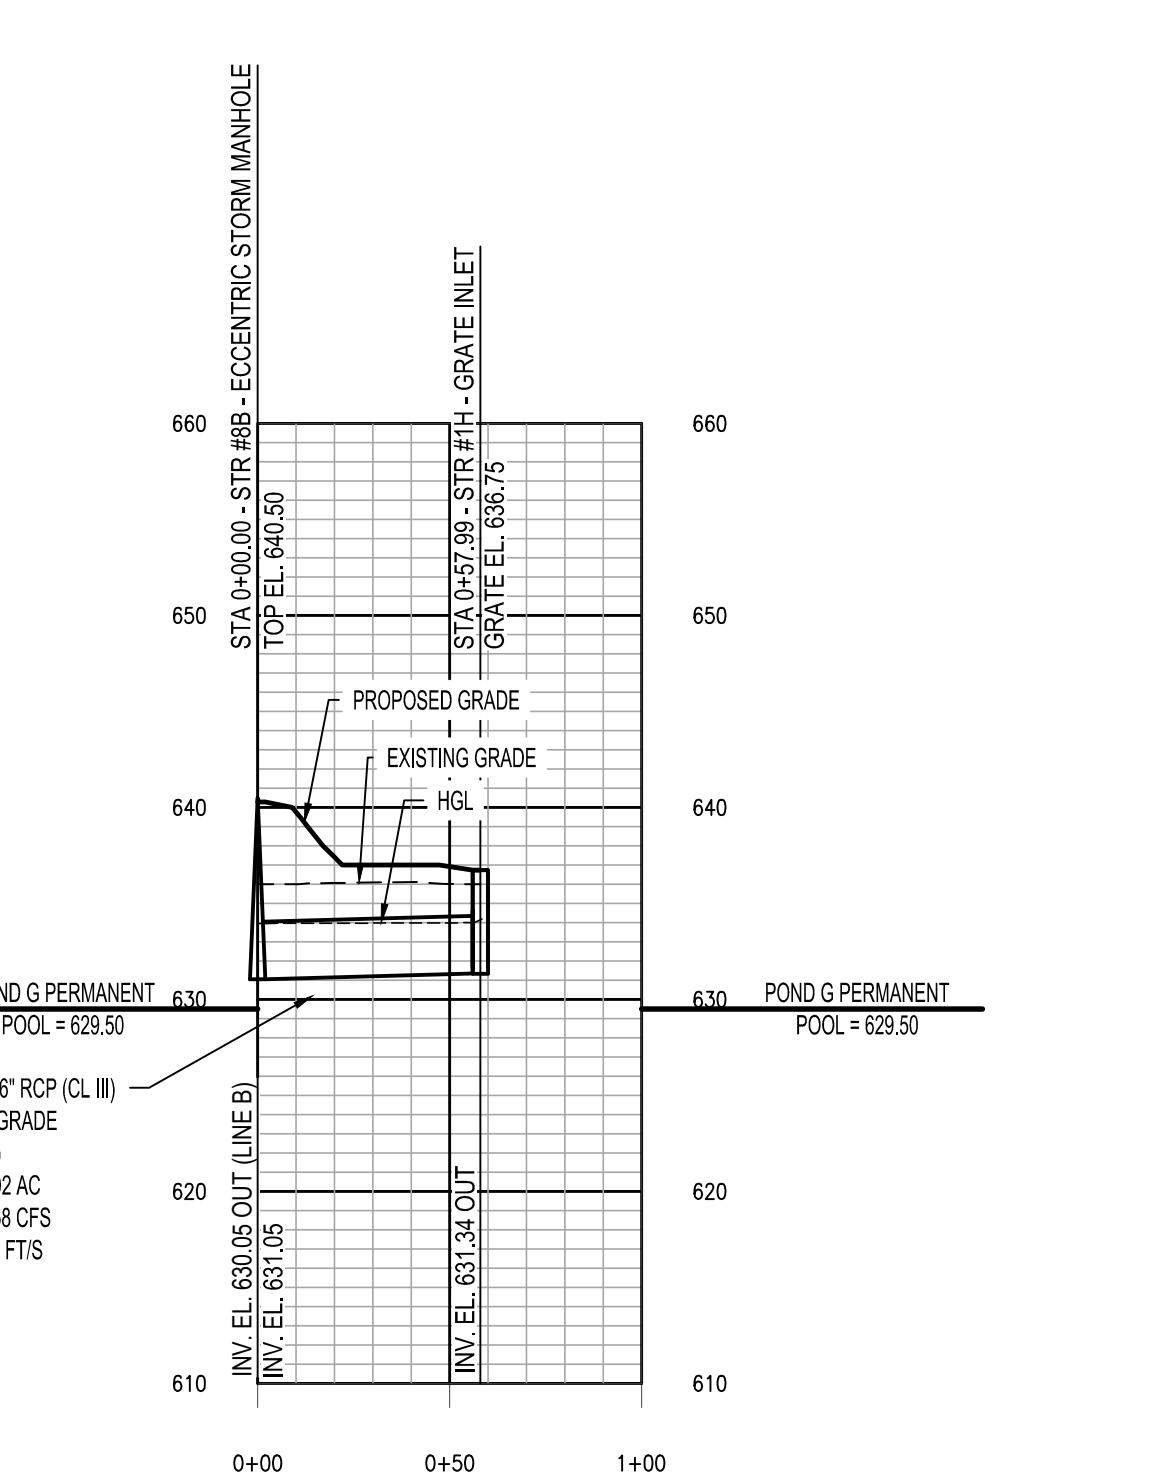


STORM LINE H

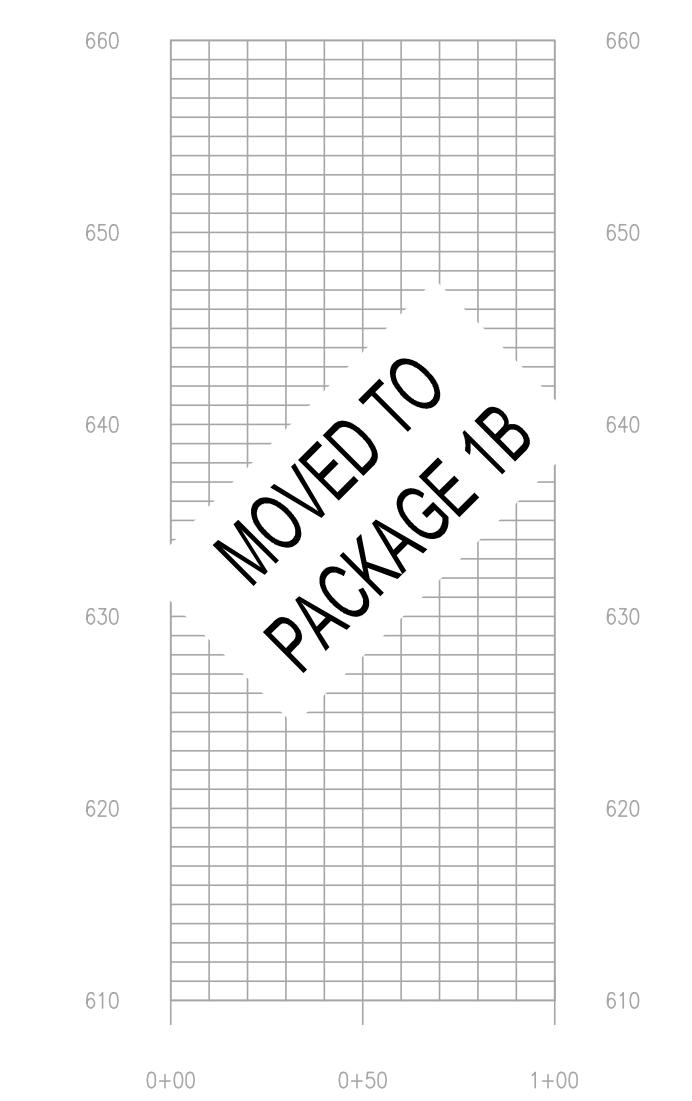

STORM LINE J

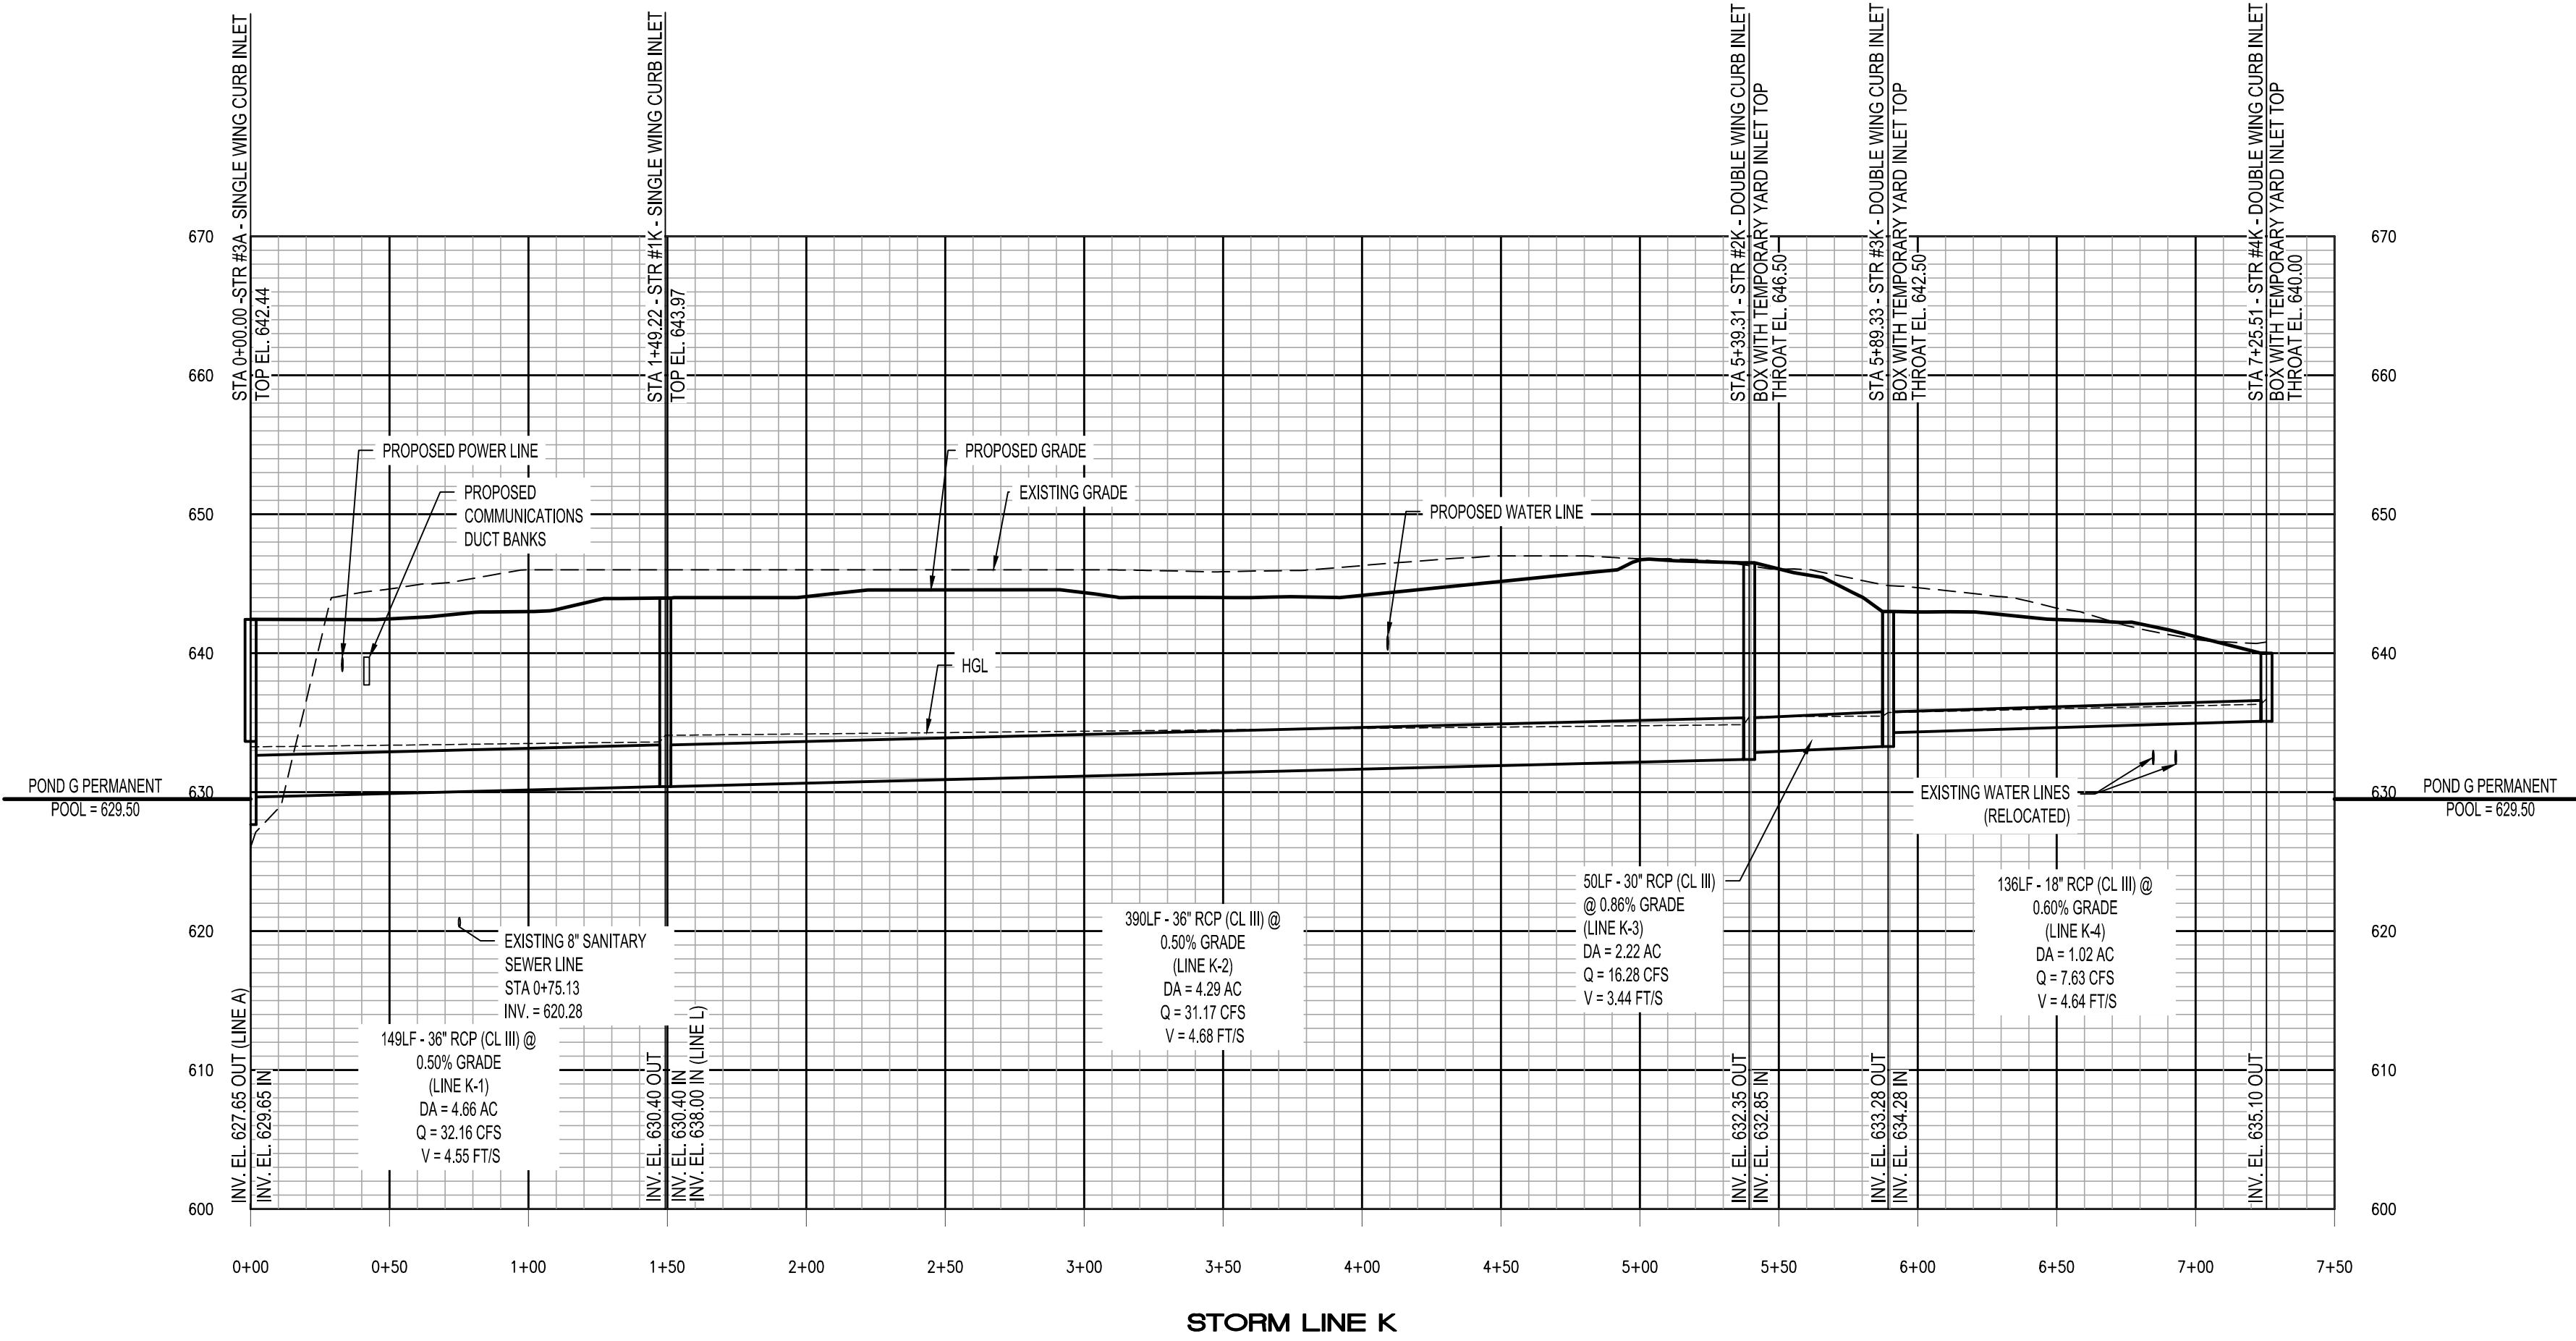

STORM LINE K

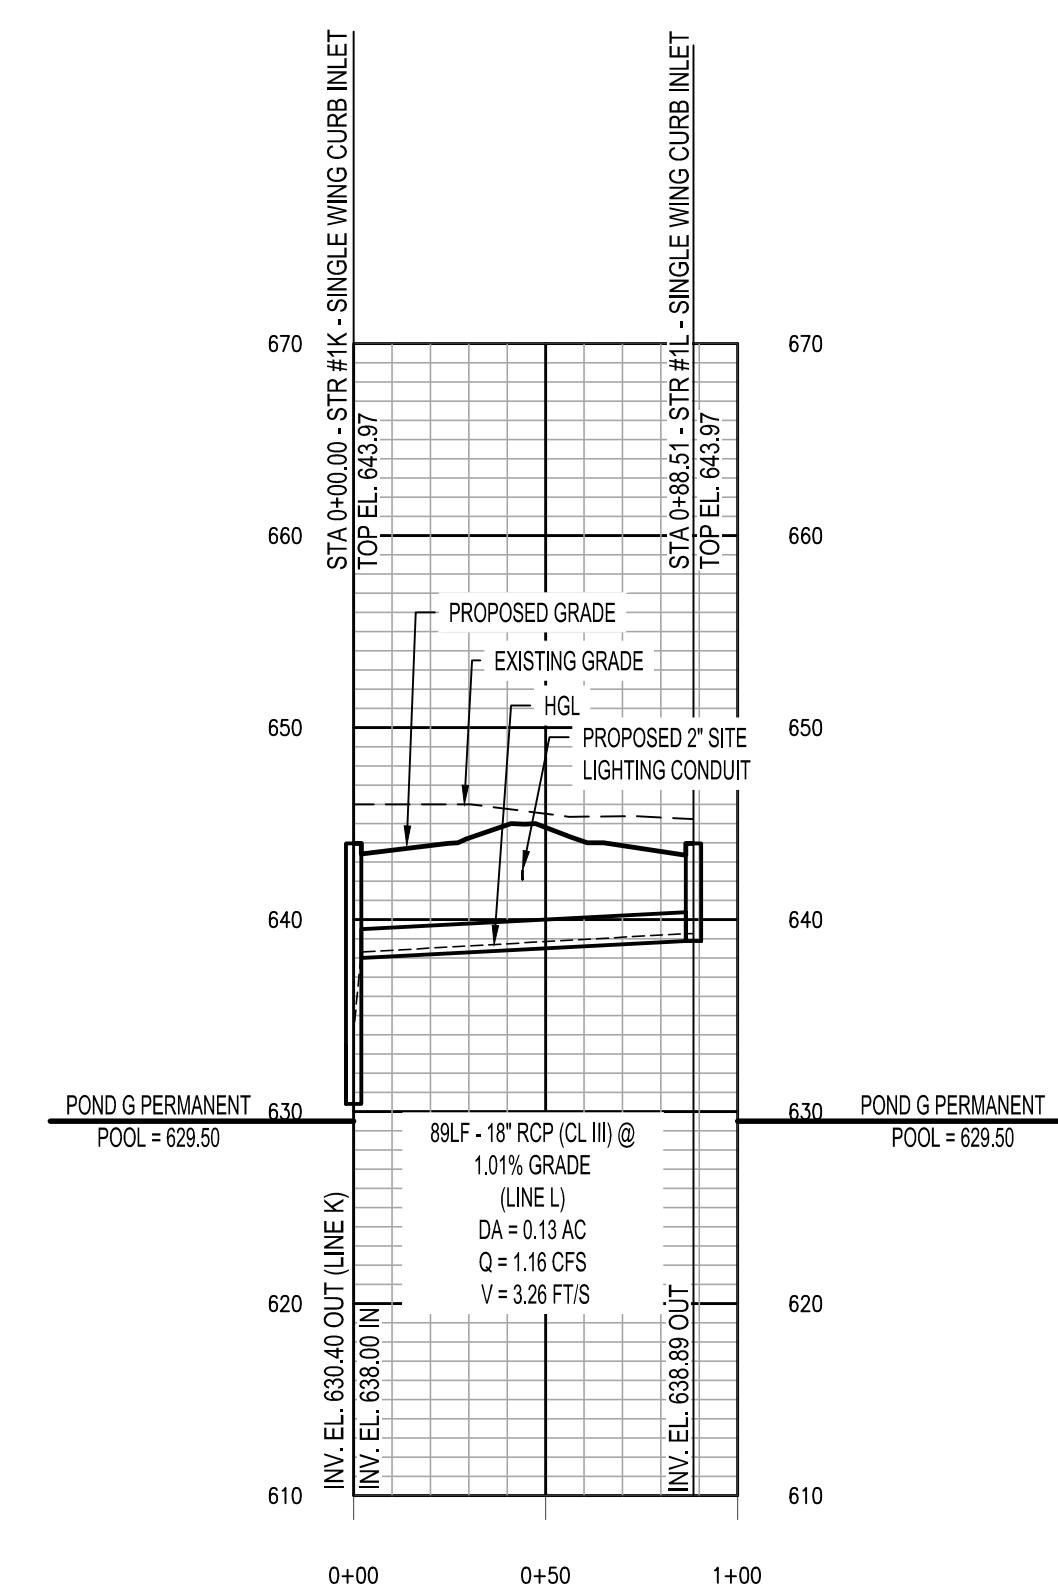

STORM LINE L

Line ID	Flow Rate (cfs)	Line Size (in)	Line Type	InvertDn (ft)	InvertUp (ft)	HGLDn (ft)	HGLUp (ft)	Line Slope (%)	Vel/Ave (ft/s)
Line G-1	181.93	60 x 96	Box	627.60	627.67	633.21	633.23	0.32	4.55
Line G-2	182.66	60 x 96	Box	627.67	628.01	633.47	633.57	0.30	4.57
Line H	22.58	36 Cir	631.05	631.34	633.95	633.99	0.50	3.32	
Line K-1	32.16	36 Cir	629.65	630.40	633.26	633.61	0.50	4.55	
Line K-2	31.17	36 Cir	630.40	632.35	634.09	634.95	0.50	4.68	
Line K-3	16.28	30 Cir	632.85	633.28	635.42	635.47	0.86	3.44	
Line K-4	7.63	18 Cir	634.28	635.10	635.73	636.33	0.60	4.64	
Line	0.97	18 Cir	638.00	638.89	638.31	639.27	1.01	3.26	

\* POND F PERMANENT POOL ELEVATION = 633.50 (FINAL DEVELOPMENT).  
\*\* POND G PERMANENT POOL ELEVATION = 629.50 (FINAL DEVELOPMENT).

SPECIAL NOTES:  
1. PIPES SIZED FOR THE 25-YEAR STORM UNLESS OTHERWISE NOTED.  
2. STORM LINE A SIZED FOR 100 YR ROUTED.  
3. SEE SHEETS C8.0 TO C8.5 FOR GRADING INFORMATION.  
4. SEE SHEETS C9.0 TO C9.5 FOR STORM PIPE LAYOUT INFORMATION.

SCALE:  
1=50' HORIZONTAL  
1=10' VERTICAL  
HGL  
EXISTING GRADE  
PROPOSED GRADE  
STORM SEWER

**C9.8**

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**302-10-002A**


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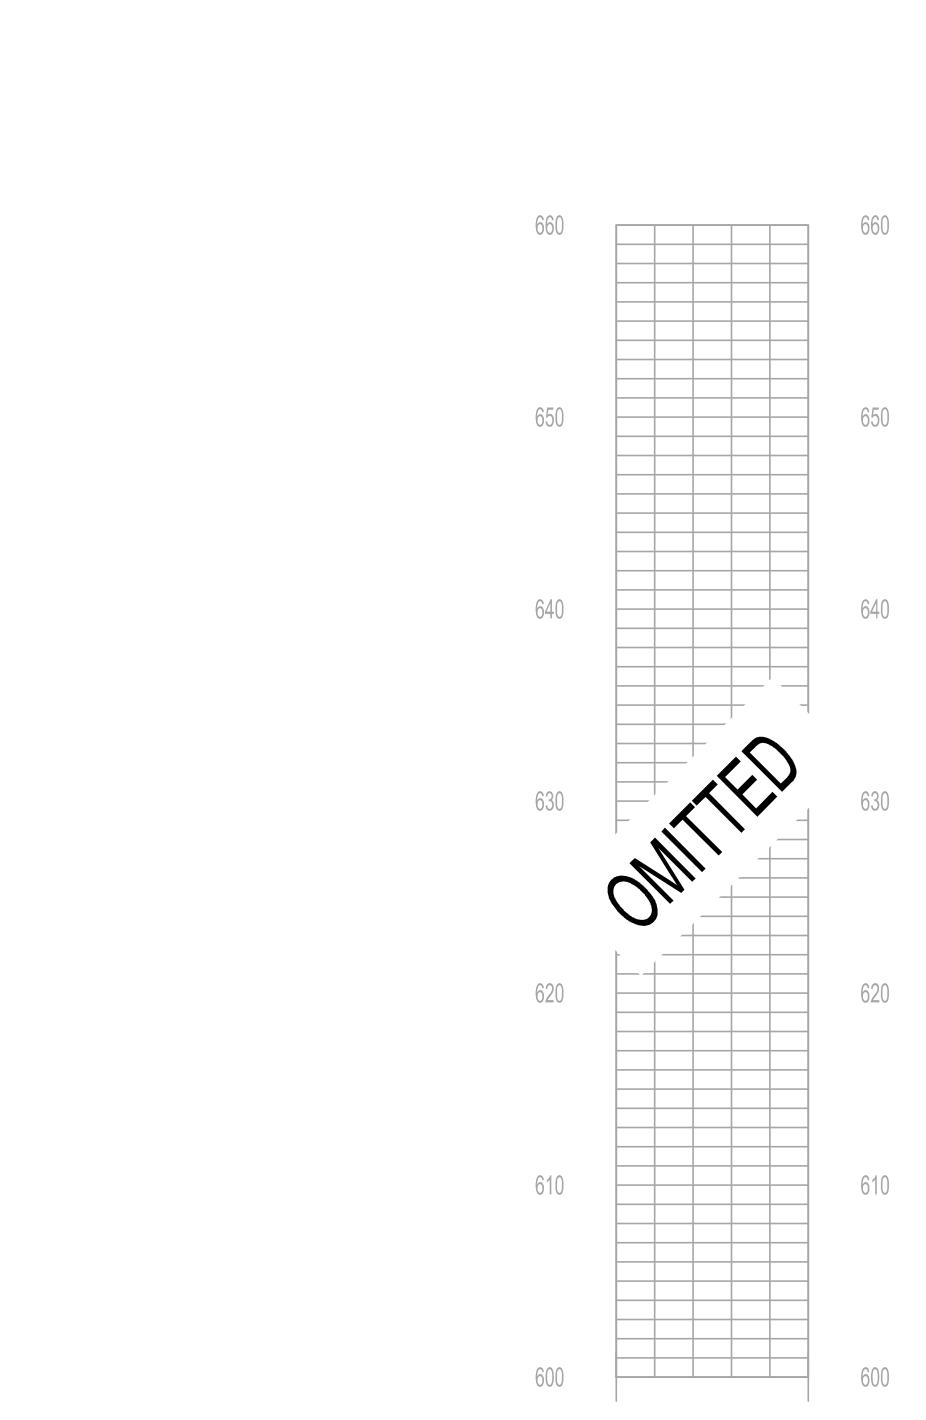


**HUNTSVILLE**  
The Star of Alabama


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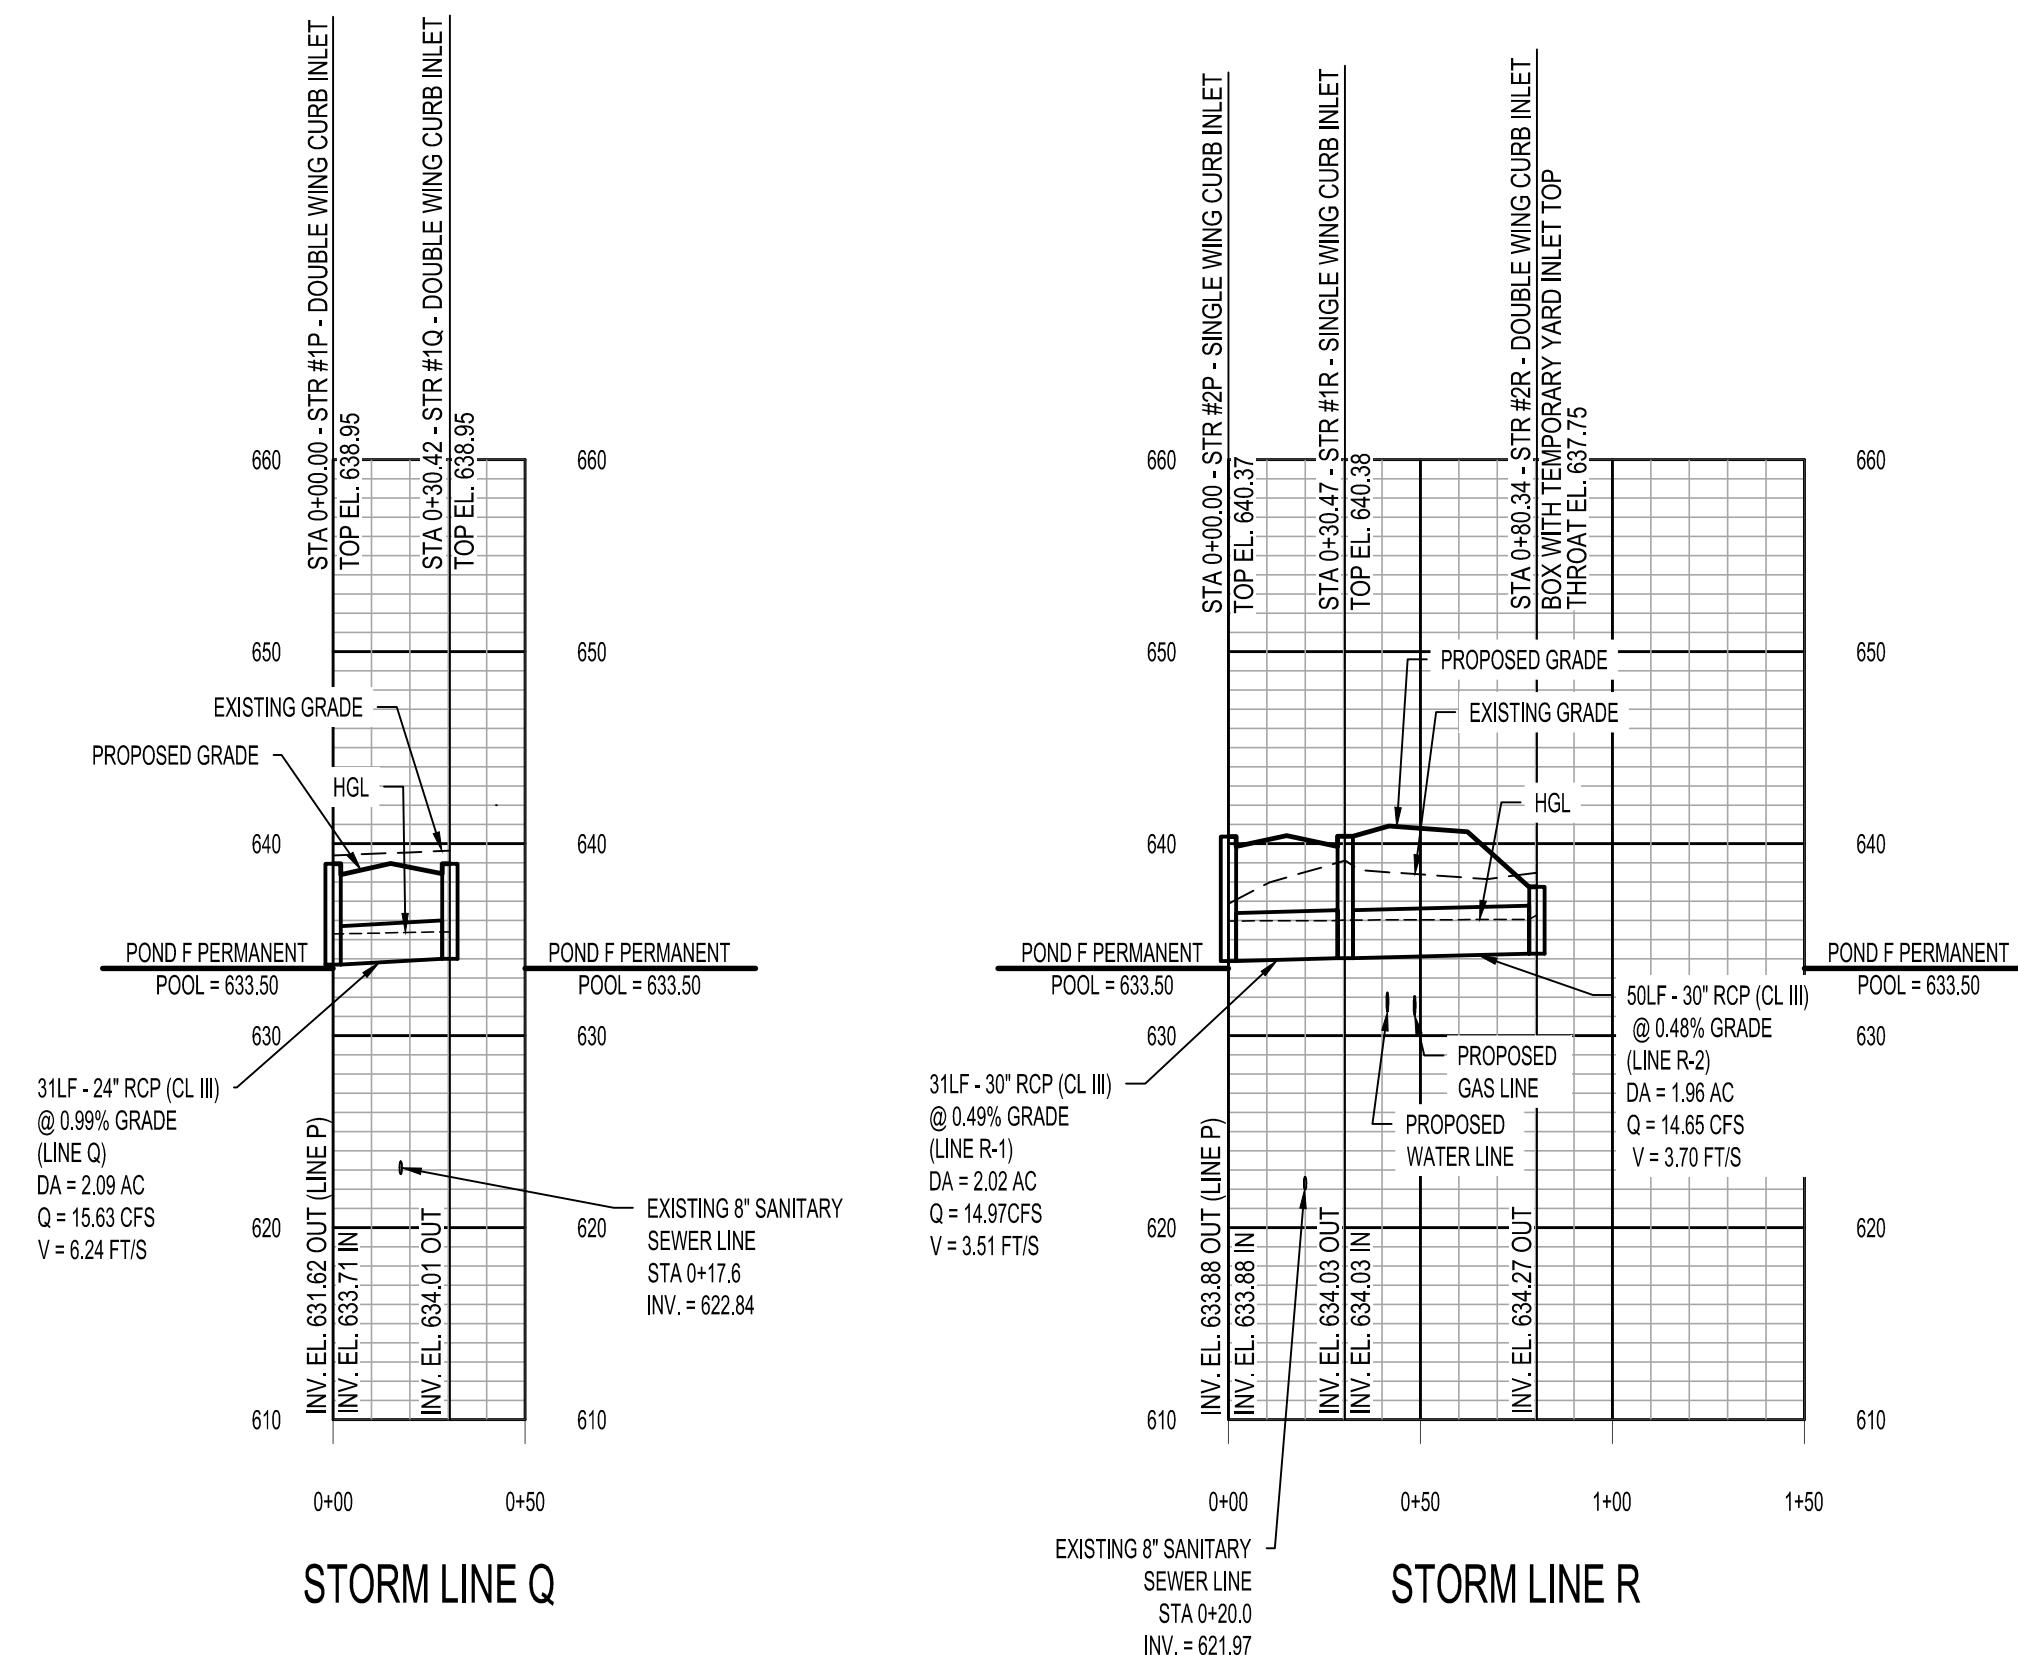
STORM LINE M




STORM LINE N

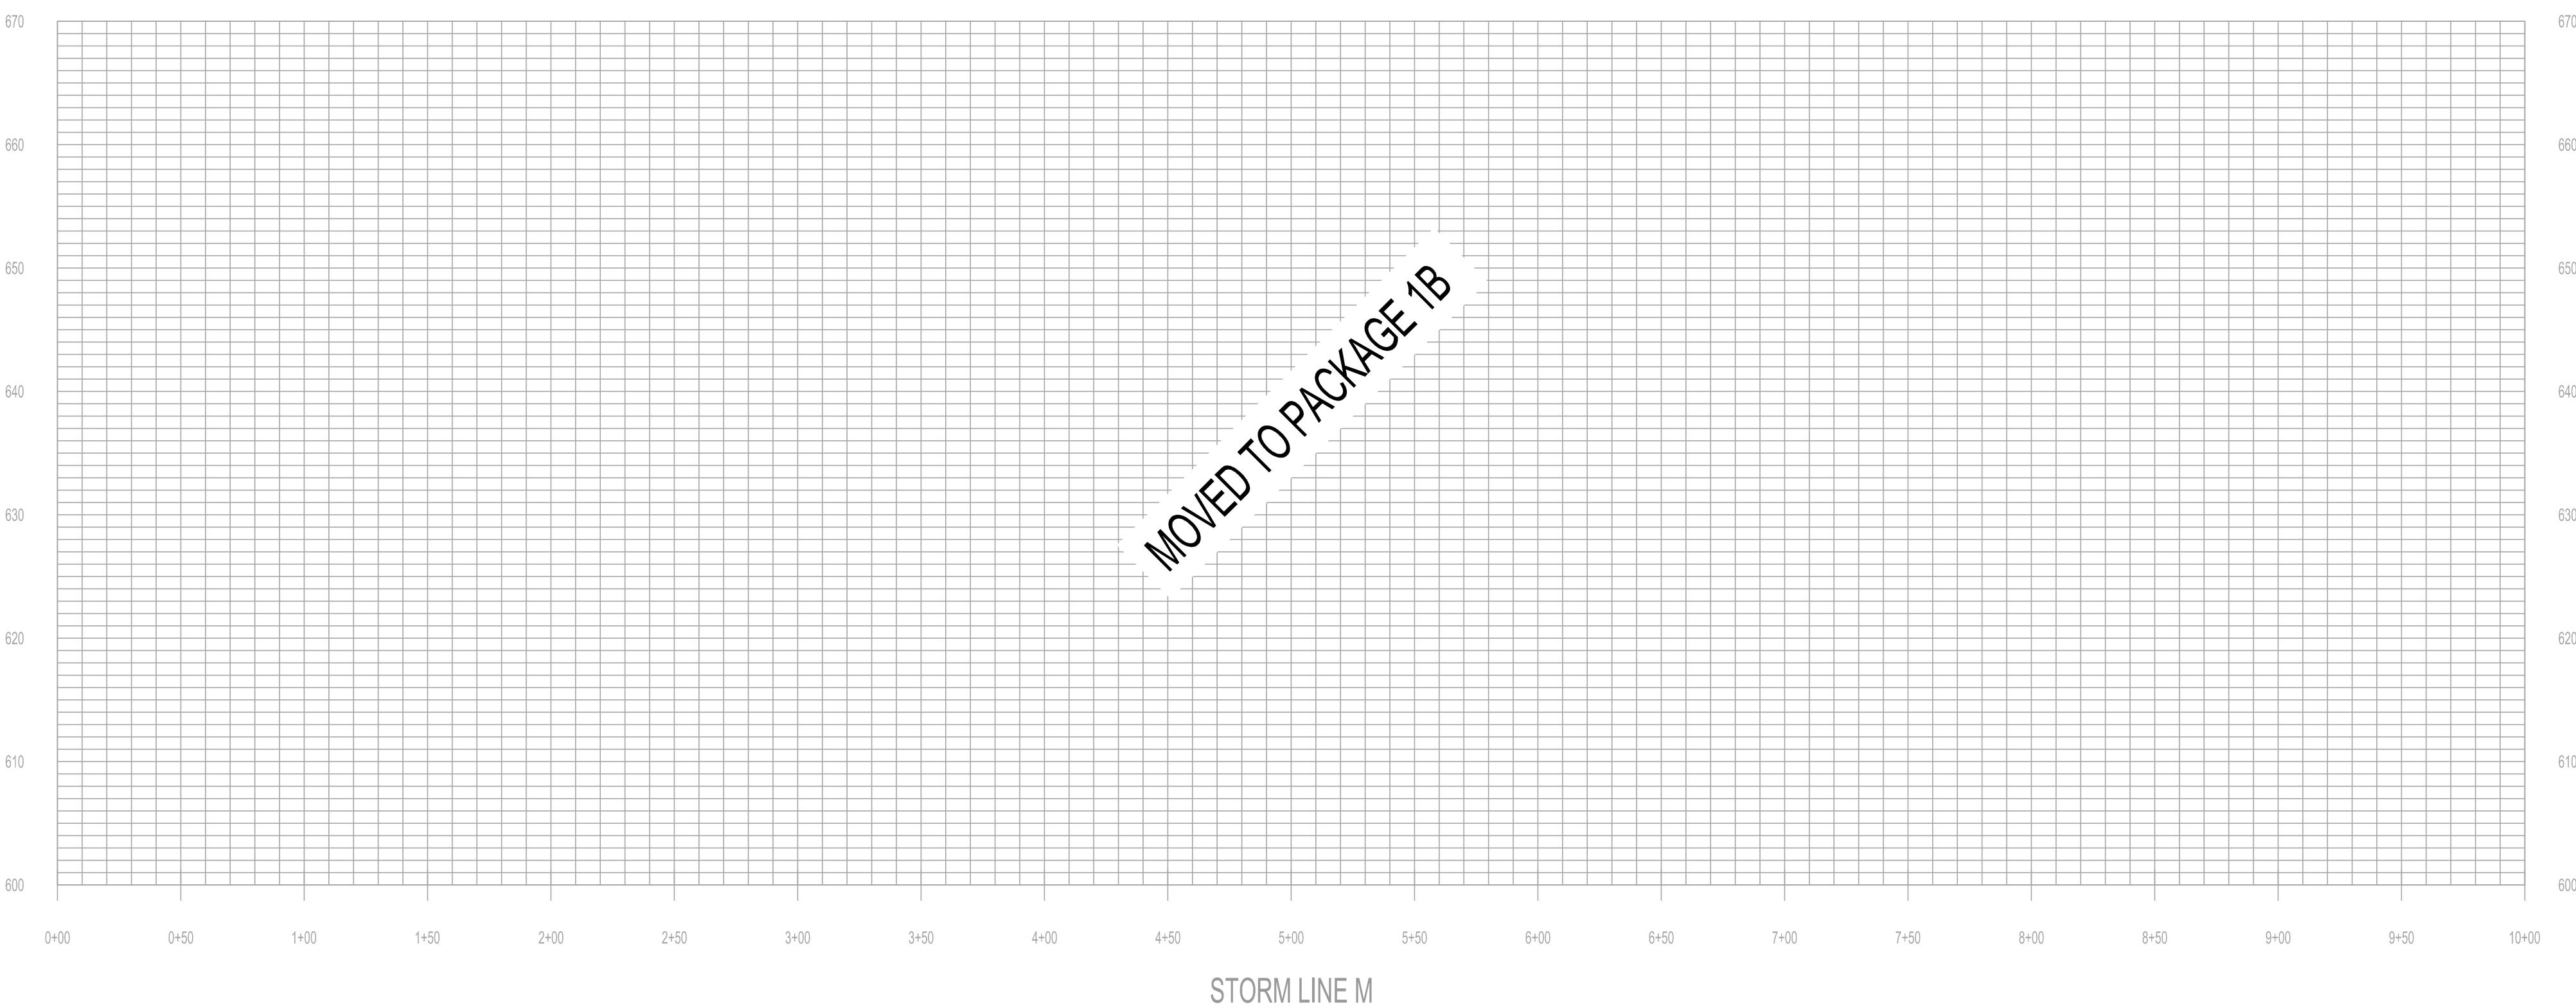

STORM LINE P

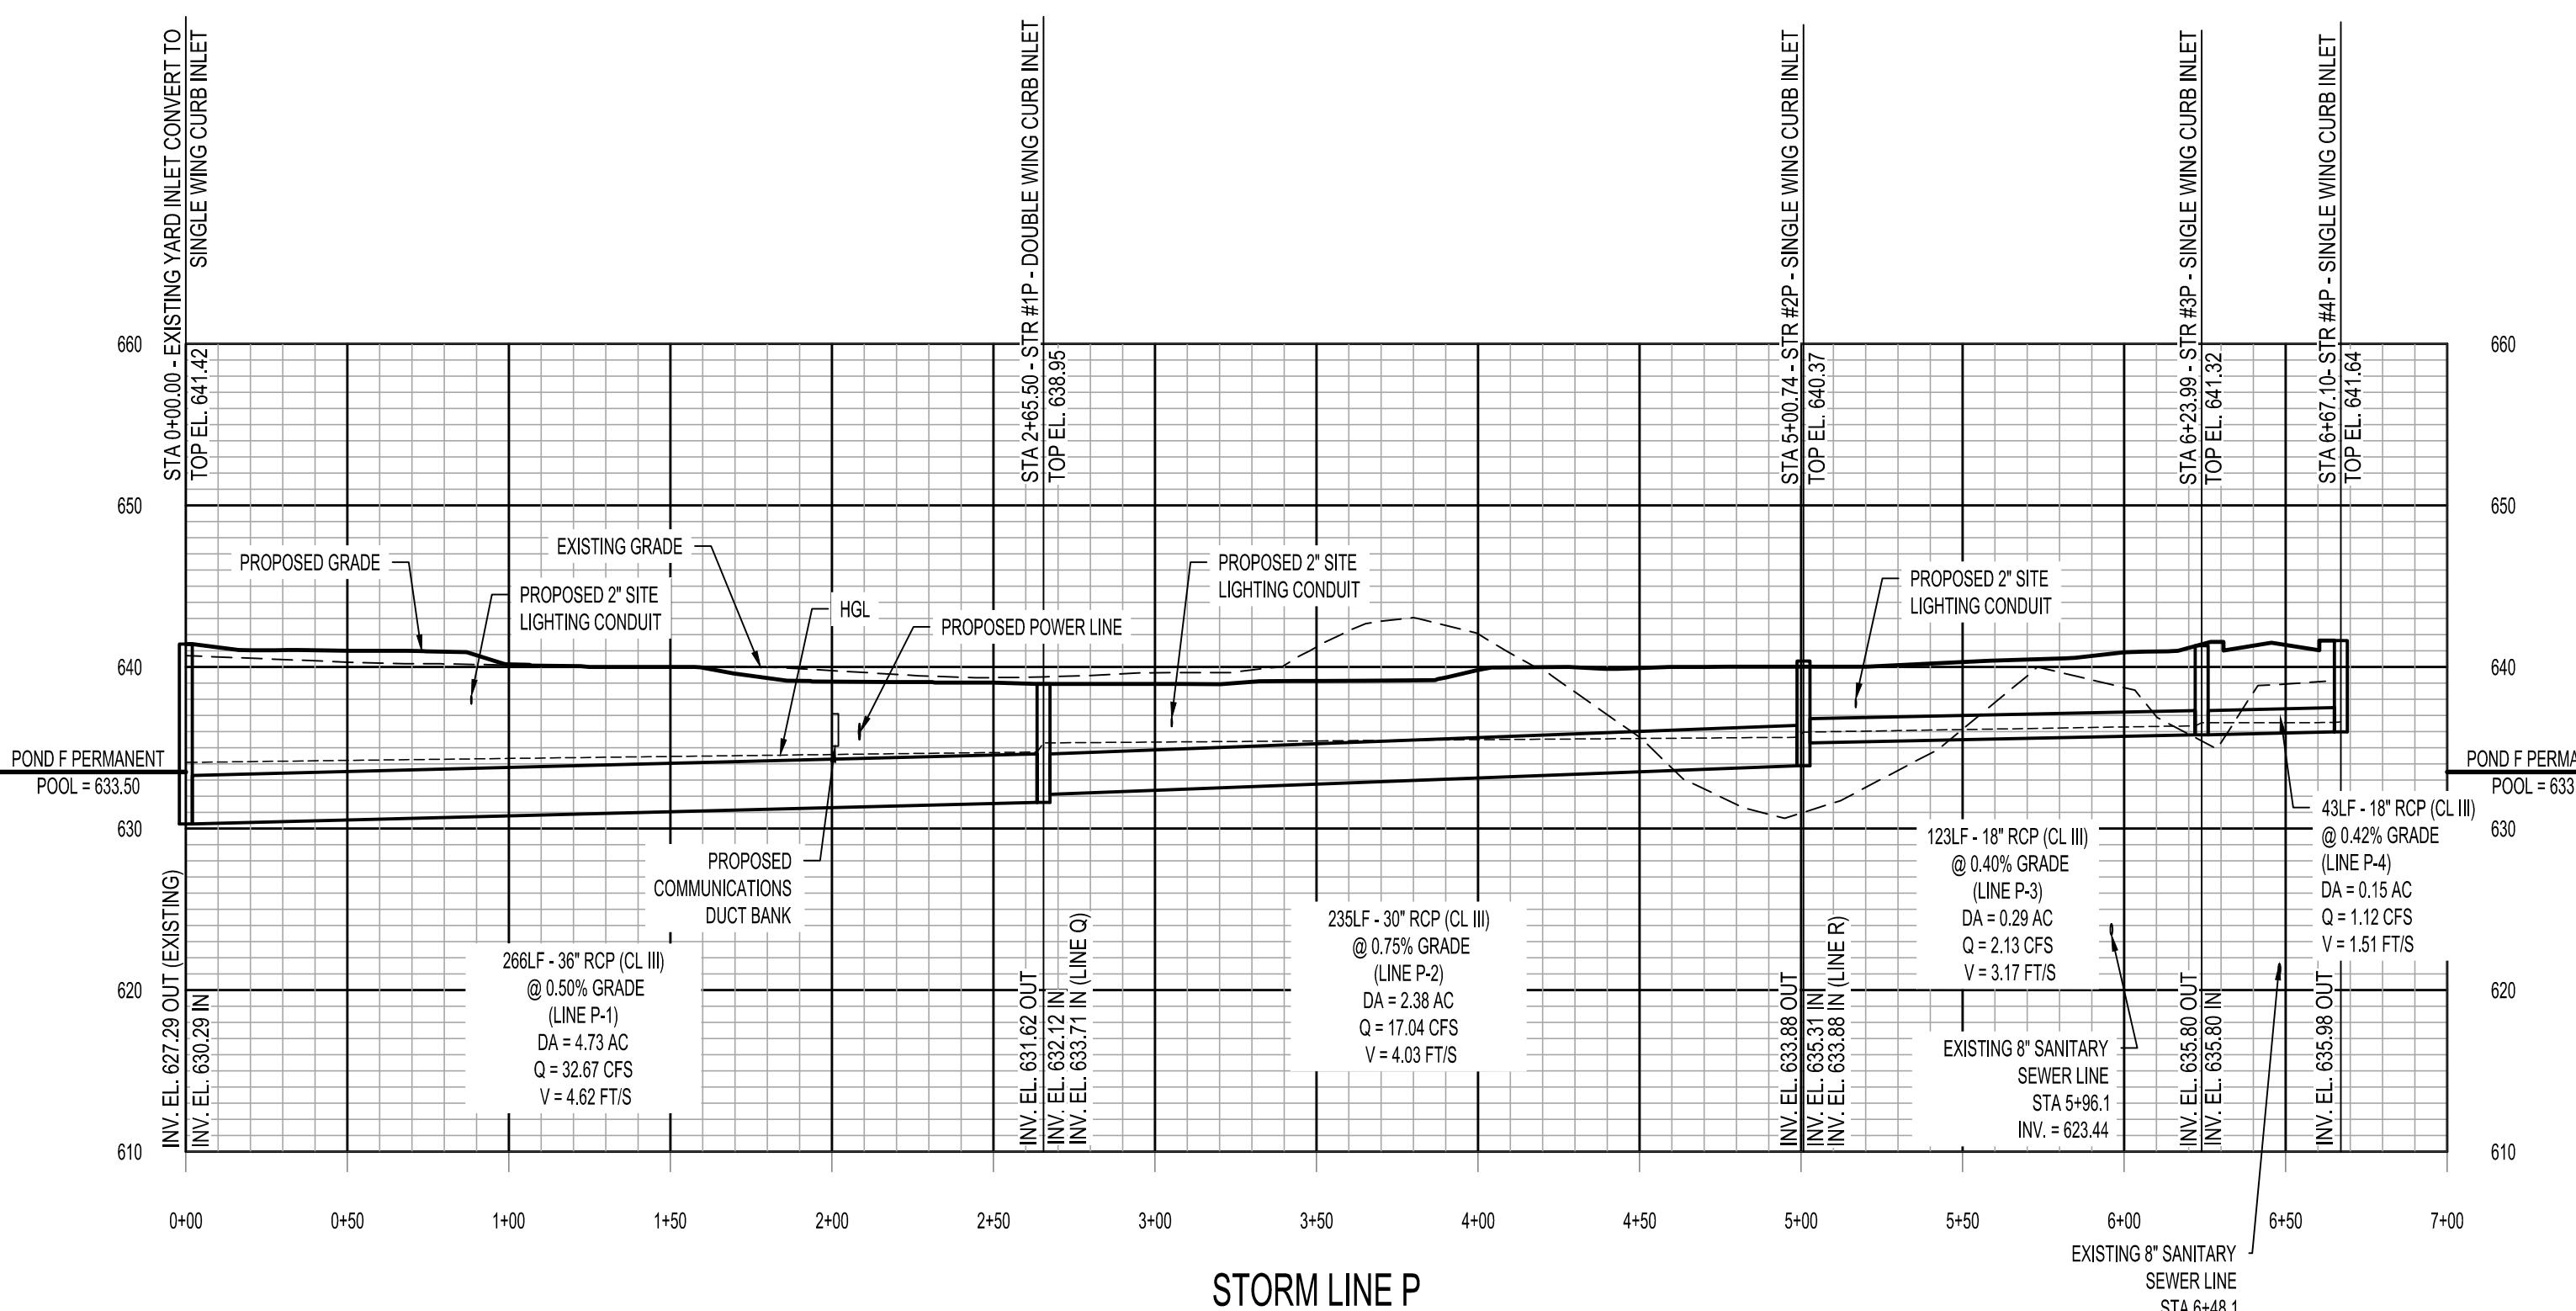

STORM LINE Q

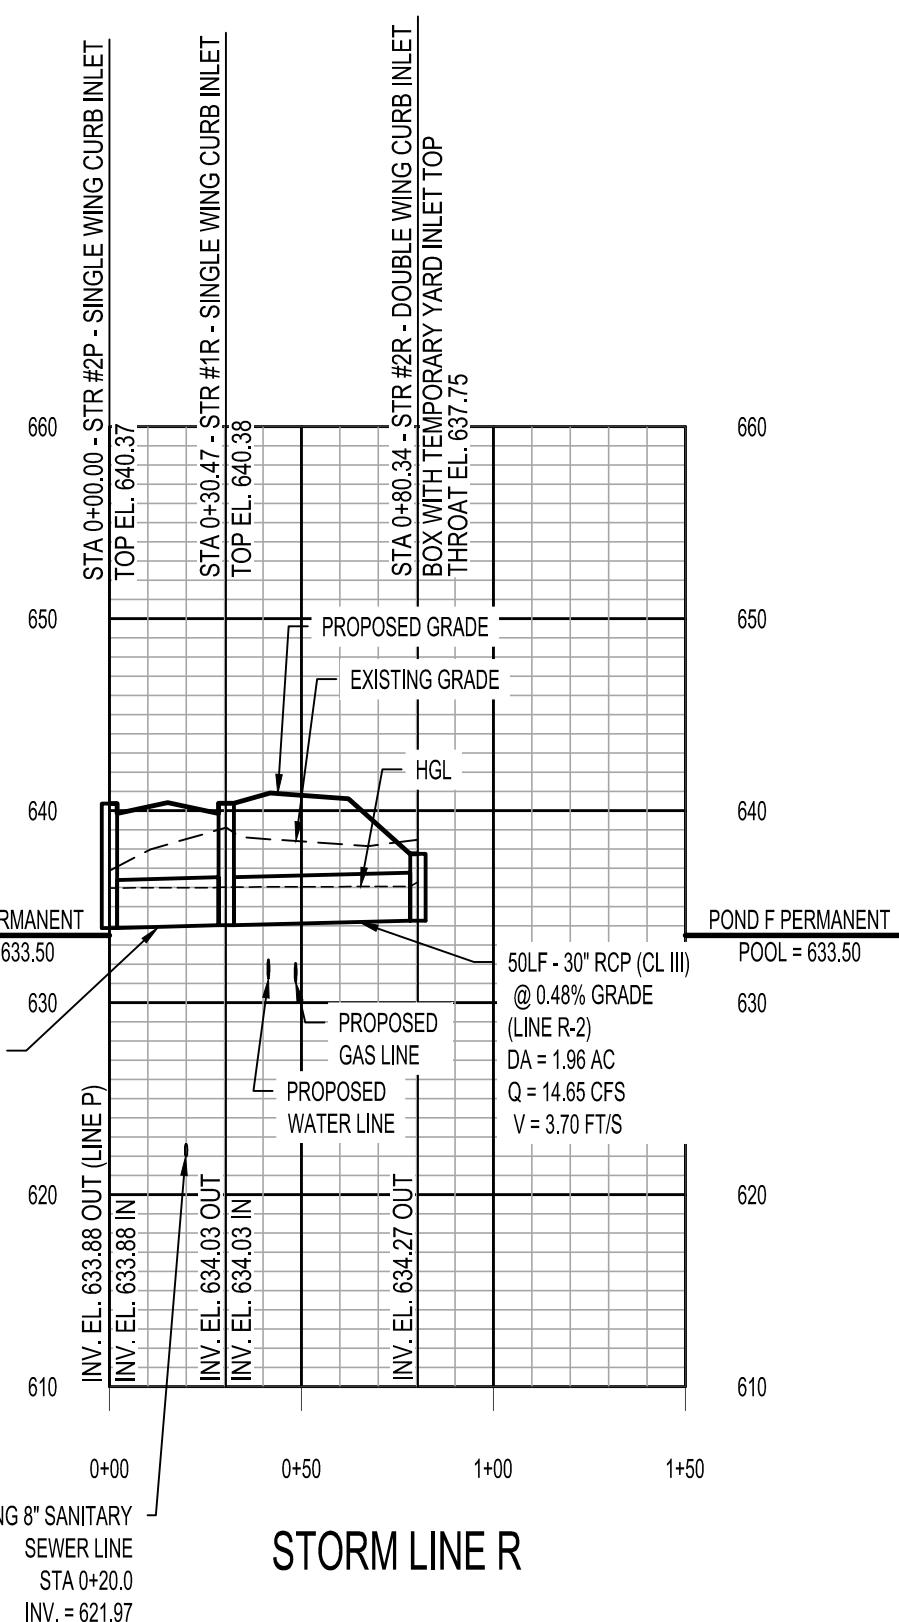

STORM LINE R

Line ID	FlowRate (cfs)	Line Size (in)	Line Type	InvertDn (ft)	InvertUp (ft)	HGLDn (ft)	HGLUp (ft)	Line Slope (%)	Vel/Ave (ft/s)
Line P-1	32.67	36.00	Cir	630.29	631.62	634.10	634.74	0.50	4.62
Line P-2	17.04	30.00	Cir	632.12	633.88	635.30	635.65	0.75	4.03
Line P-3	2.13	18.00	Cir	635.31	635.80	635.98	636.36	0.40	3.17
Line P-4	1.12	18.00	Cir	635.80	635.98	636.55	636.56	0.42	1.51
Line Q-1	15.63	24.00	Cir	633.71	634.01	635.30	635.41	0.99	6.24
Line R-1	14.97	30.00	Cir	633.88	634.03	635.98	636.00	0.49	3.51
Line R-2	14.65	30.00	Cir	634.03	634.27	636.03	636.06	0.48	3.70

- SPECIAL NOTES:  
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 2. STORM LINE A SIZED FOR 100 YR ROUTED.  
 3. SEE SHEETS C9.0 TO C9.5 FOR GRADING INFORMATION.  
 4. SEE SHEETS C9.0 TO C9.5 FOR STORM PIPE LAYOUT INFORMATION.

\* POND F PERMANENT POOL ELEVATION = 633.50 (FINAL DEVELOPMENT).  
 \*\* POND G PERMANENT POOL ELEVATION = 629.50 (FINAL DEVELOPMENT).

SCALE:  
 1"=50' HORIZONTAL  
 1"=10' VERTICAL  
 HGL  
 EXISTING GRADE  
 PROPOSED GRADE  
 STORM SEWER

**STORM PROFILES**  
**REDSTONE GATEWAY - PACKAGE 1F**  
**ROADWAY IMPROVEMENTS**  
**CITY OF HUNTSVILLE, ALABAMA**

**C9.9**

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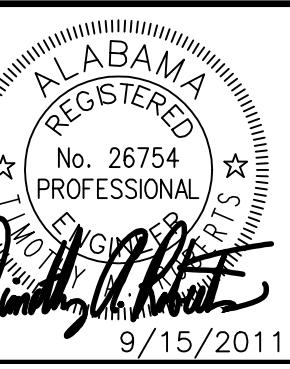


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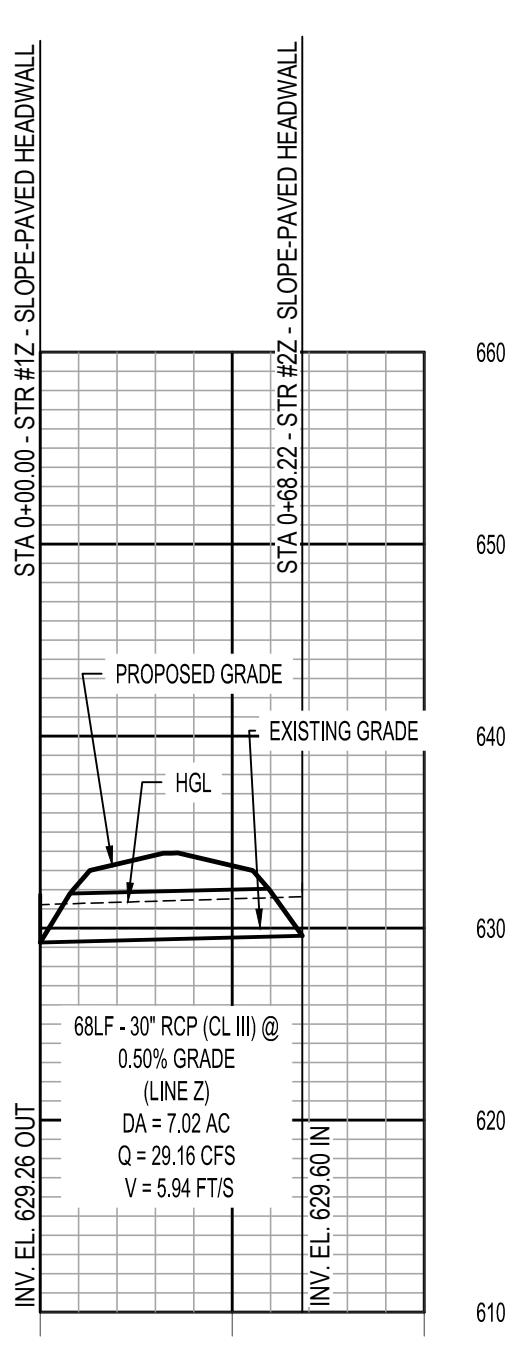
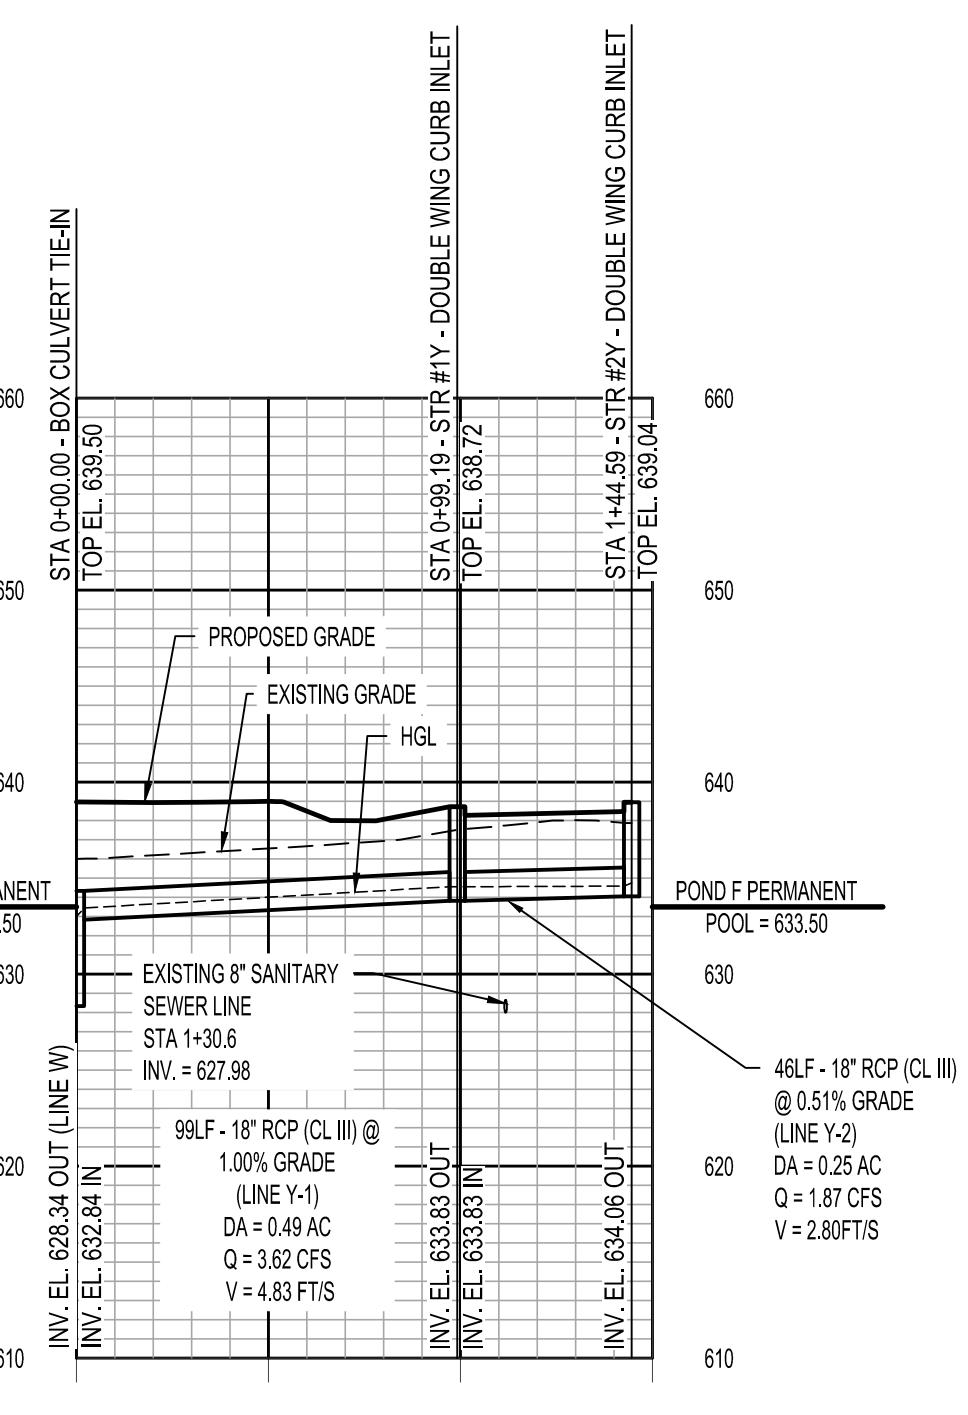
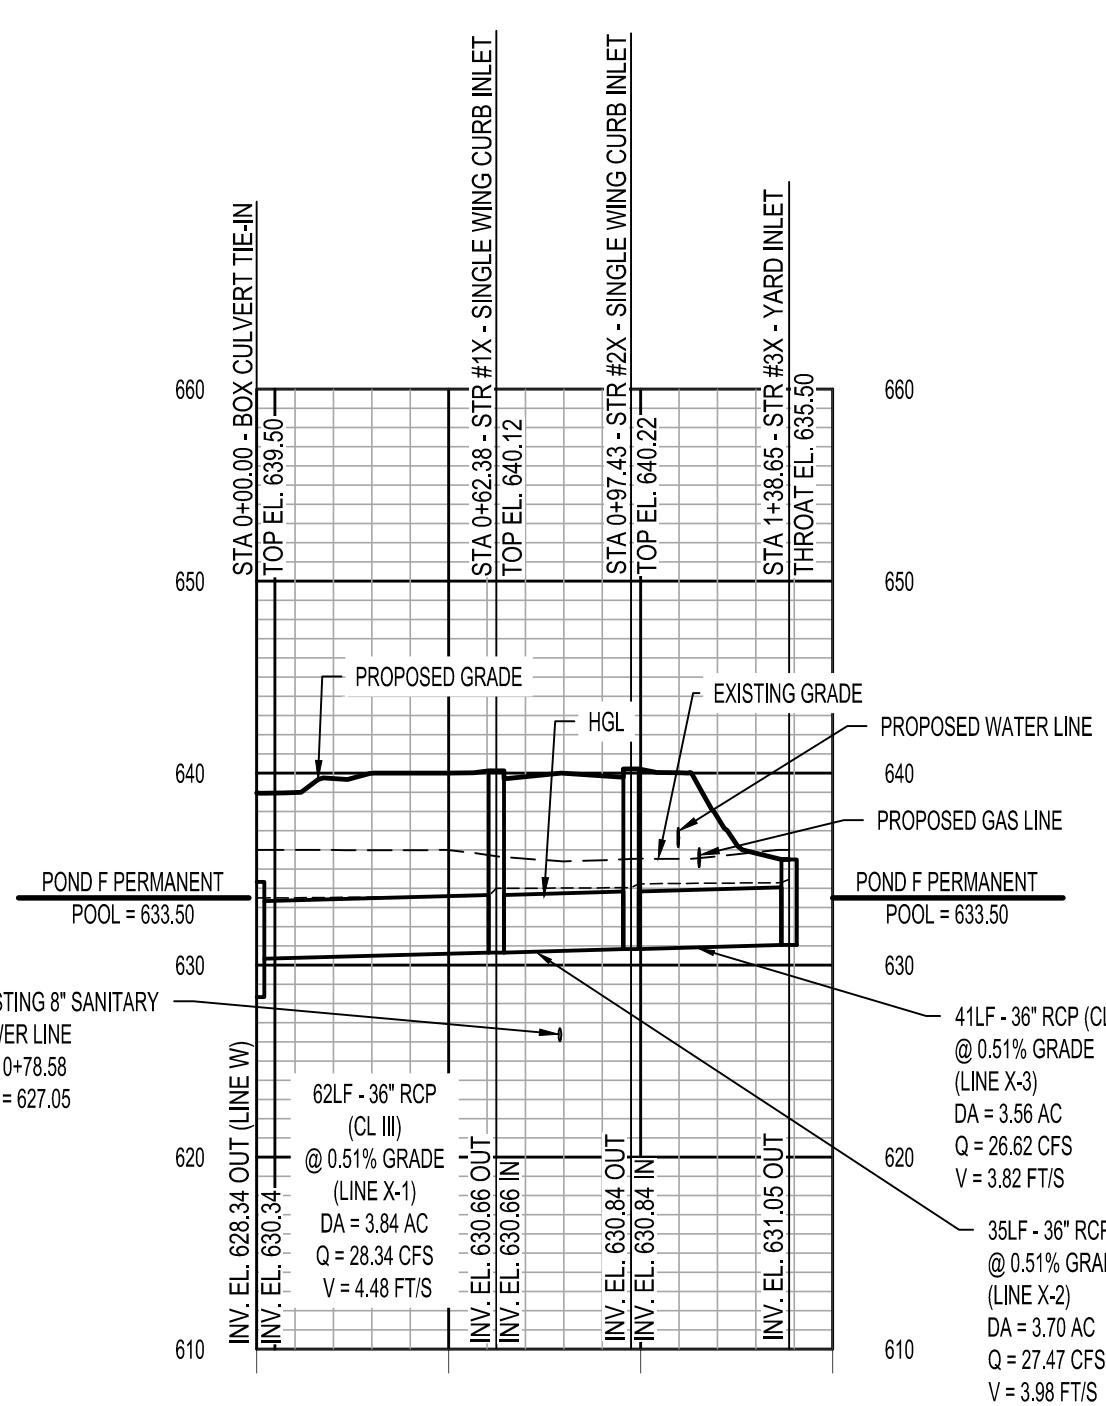
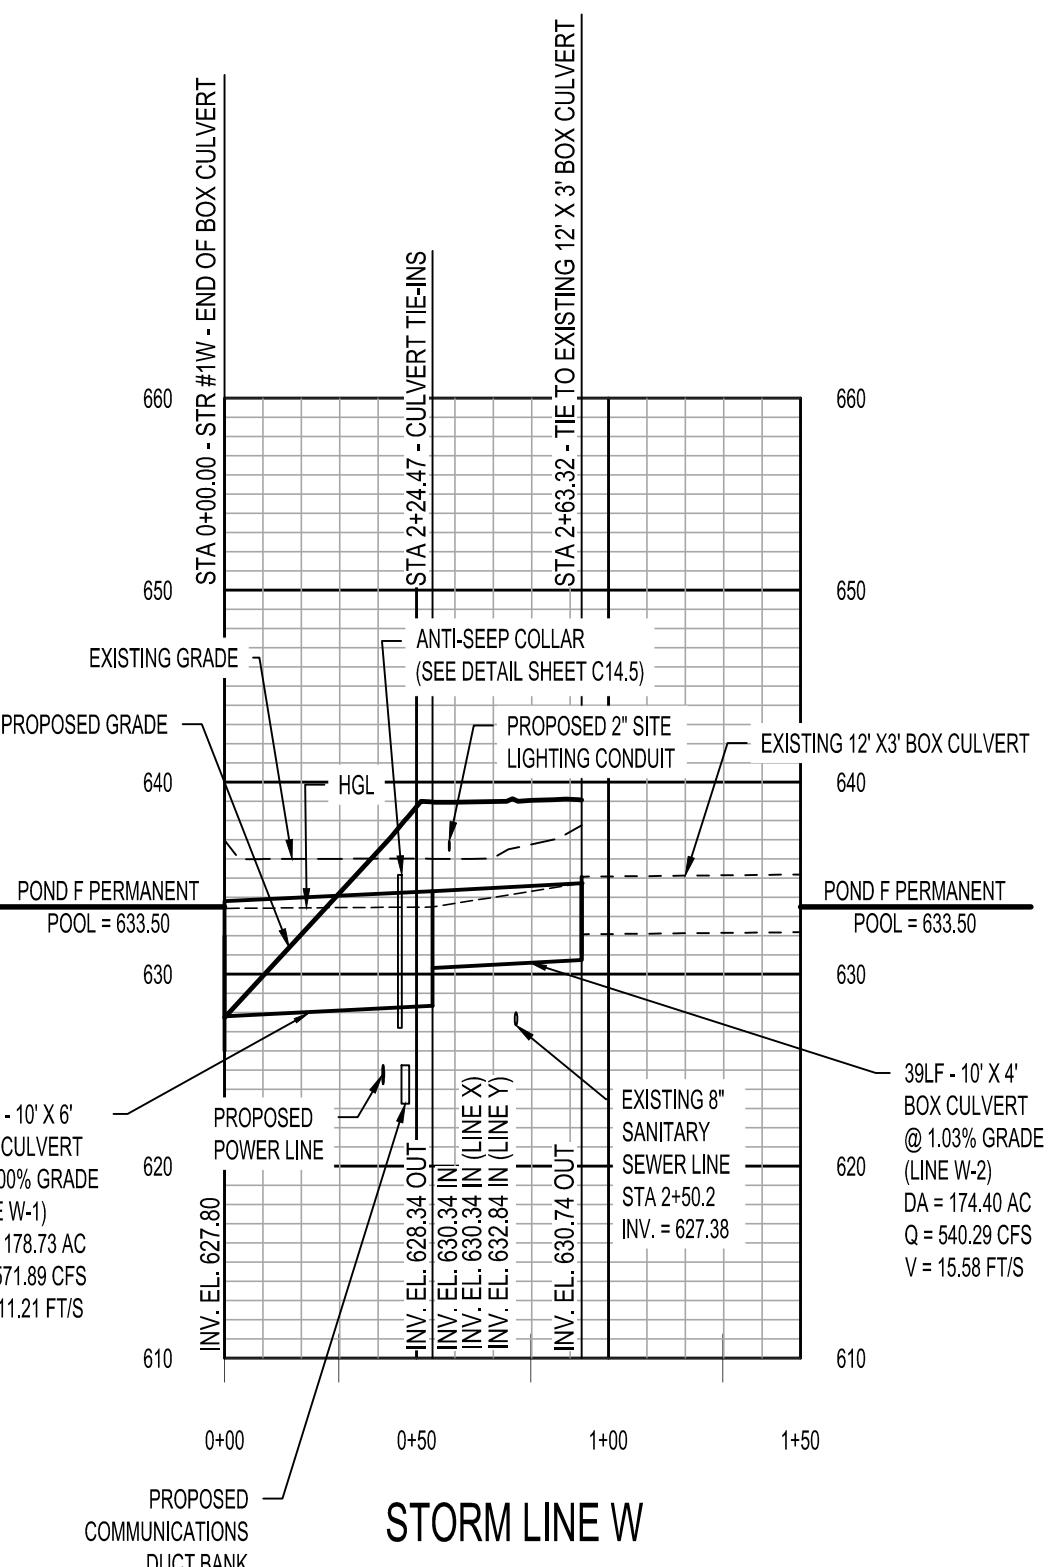
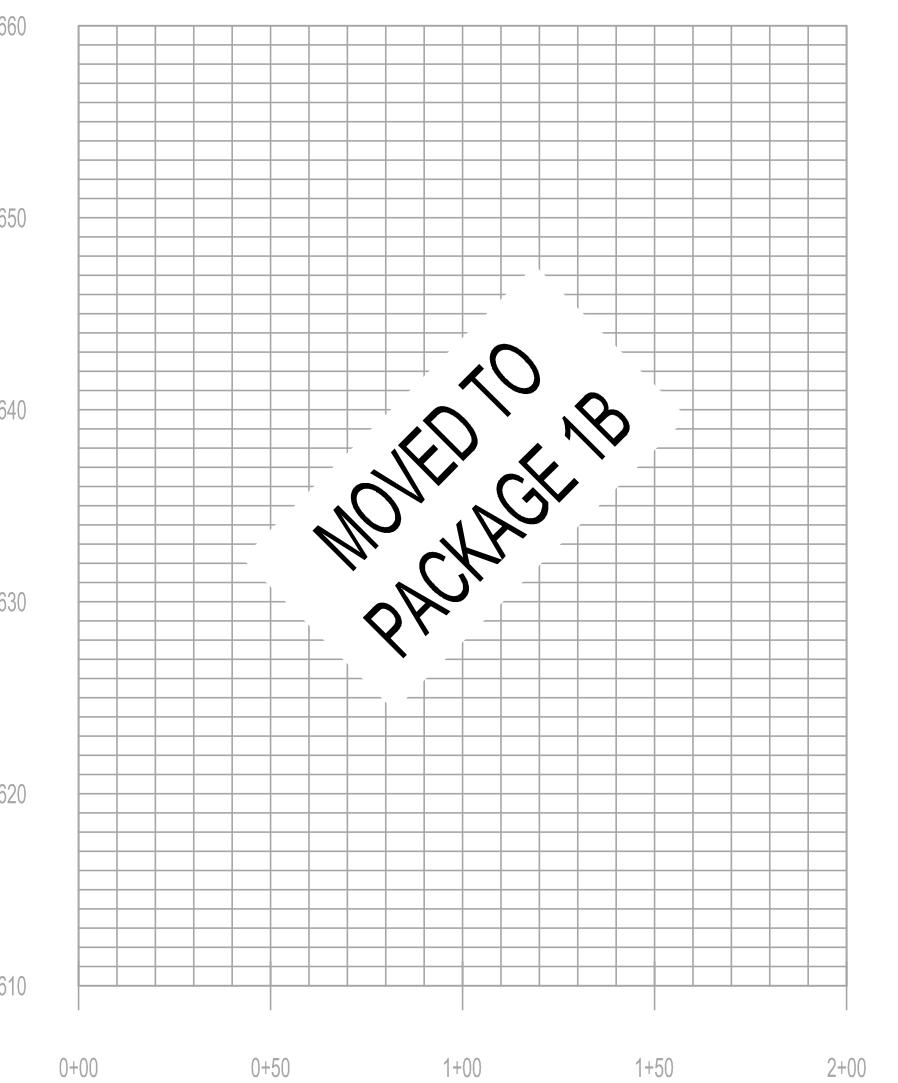
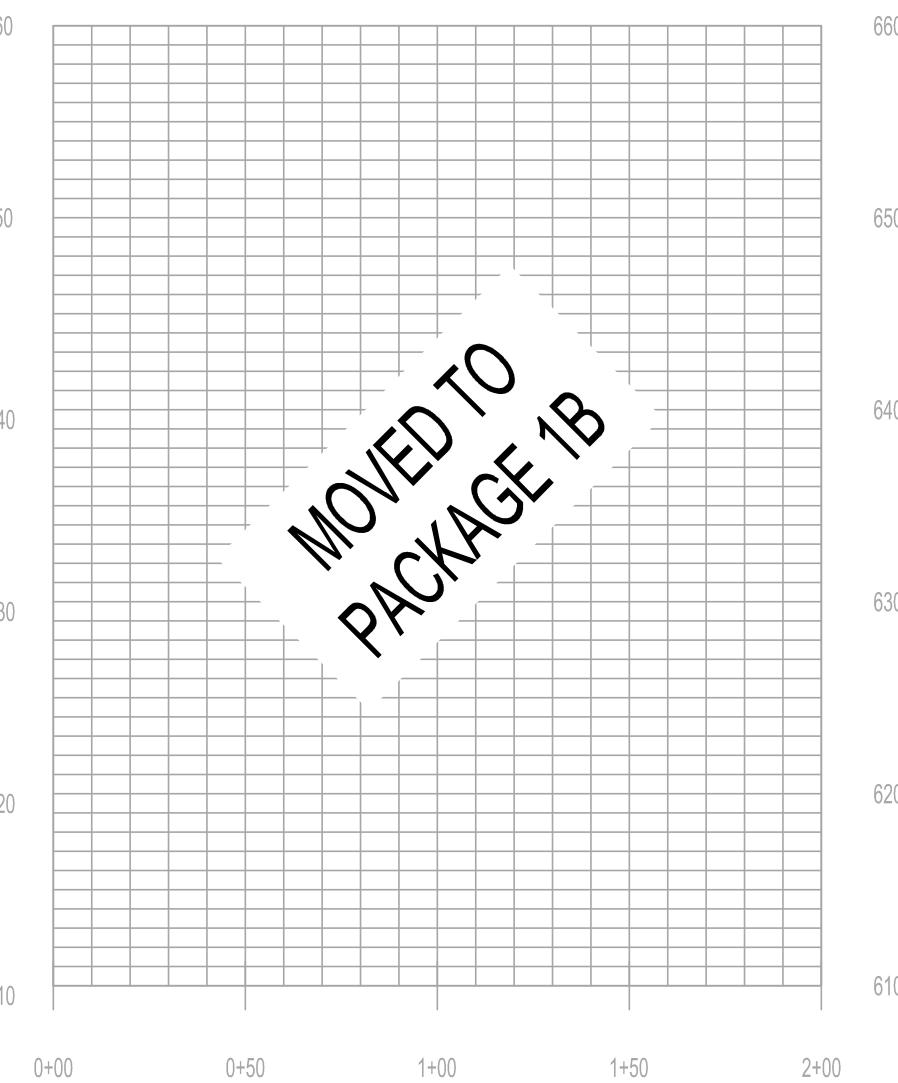
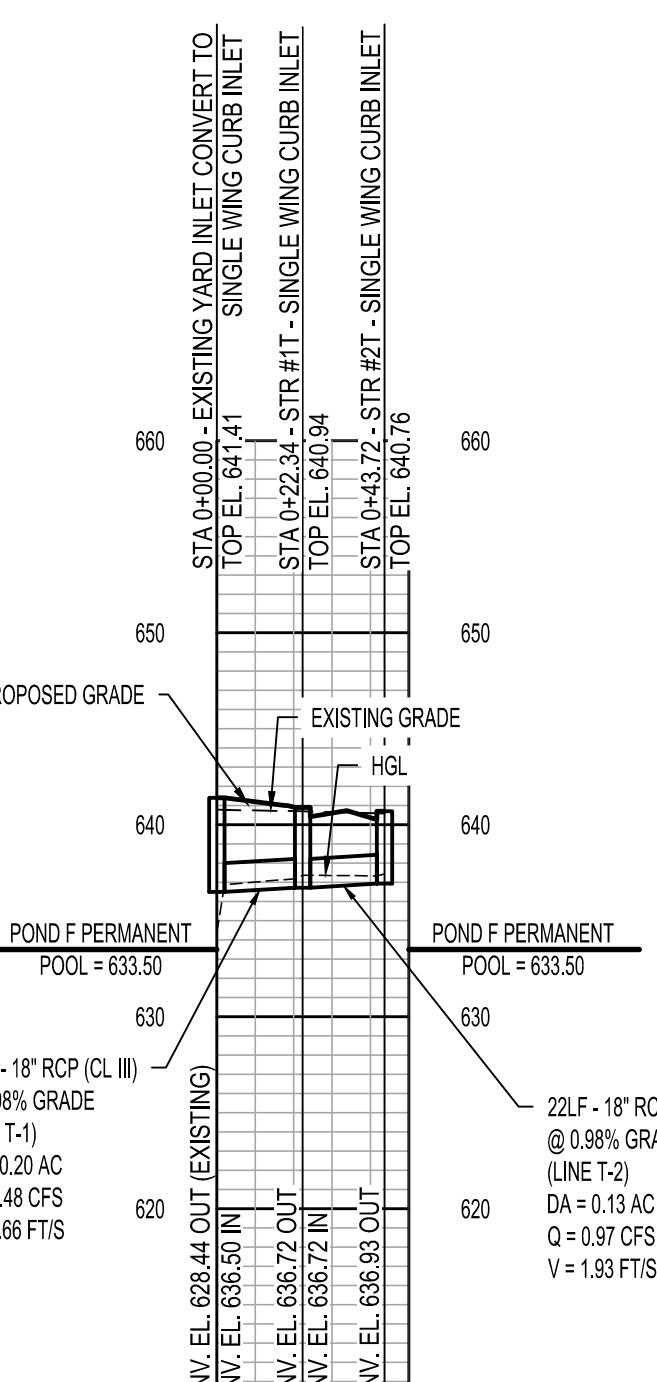
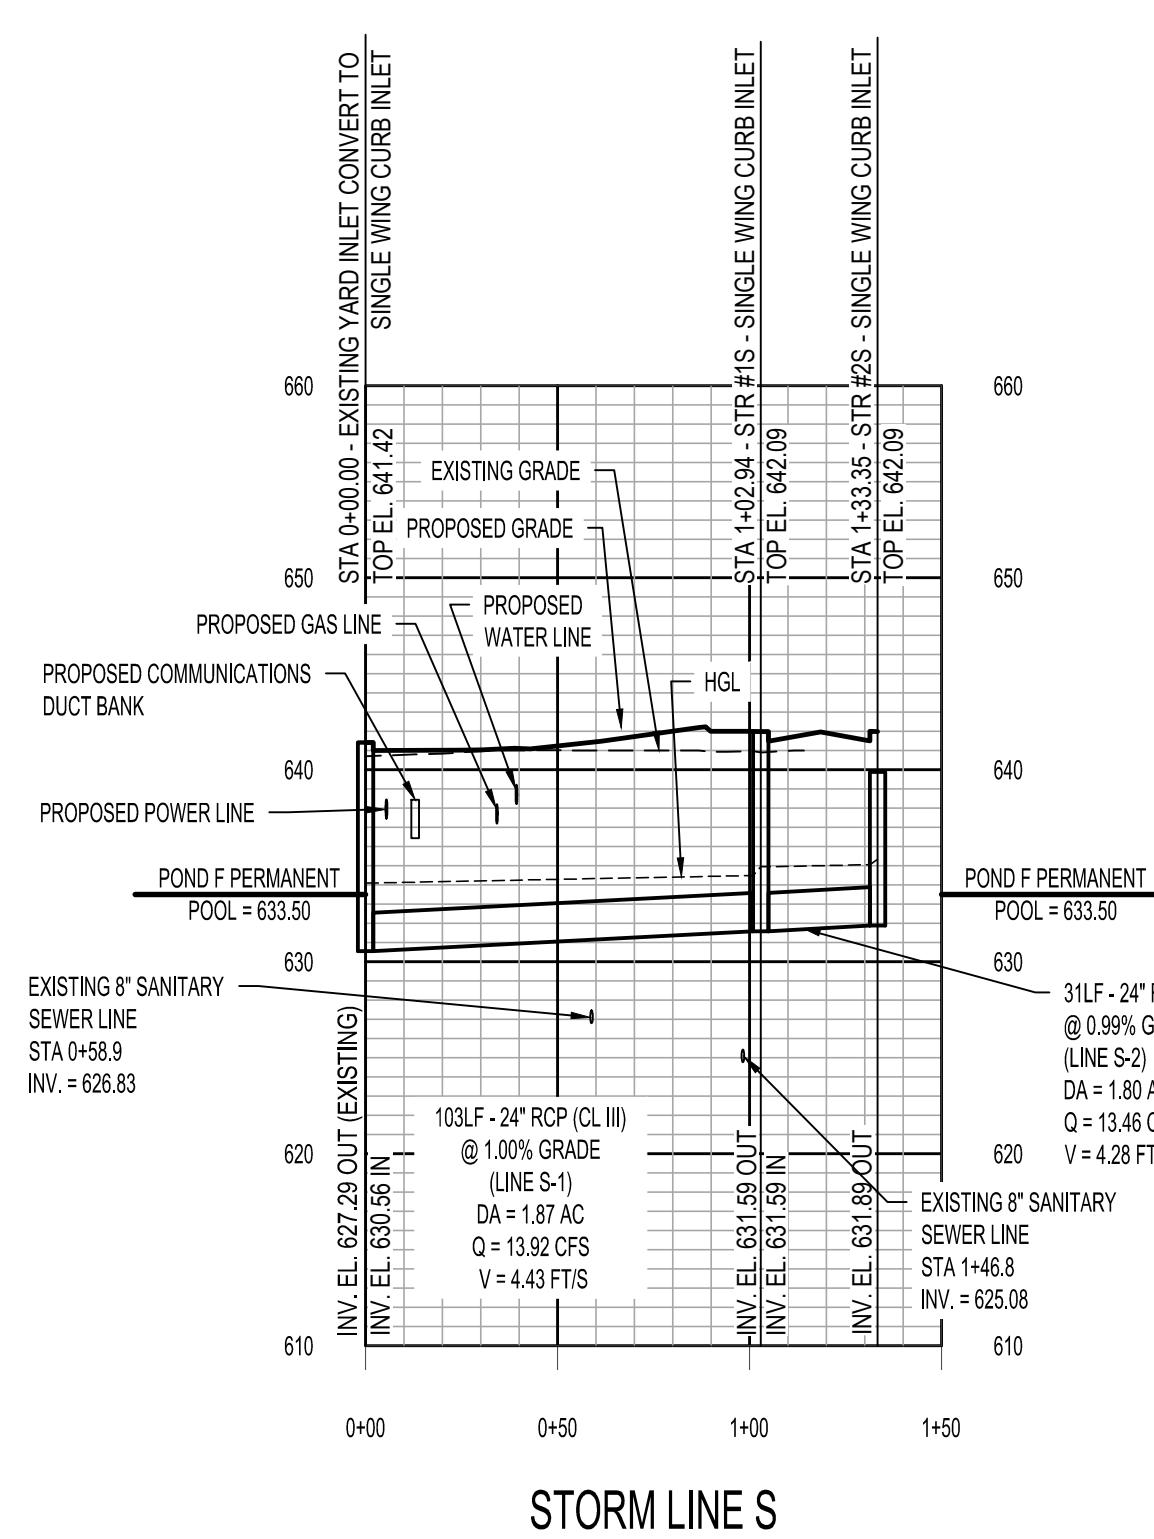
HUNTSVILLE  
The Star of Alabama

## STORM PROFILES

### REDSTONE GATEWAY - PACKAGE 1F

#### ROADWAY IMPROVEMENTS

#### CITY OF HUNTSVILLE, ALABAMA



LineID	FlowRate (cfs)	LineSize (in)	LineType	InvertDn (ft)	InvertUp (ft)	HGLdn (ft)	HGLup (ft)	LineSlope (%)	VelAve (ft/s)
Line S-1	13.92	24.00	Cir	630.56	631.59	634.10	634.49	1.00	4.43
Line S-2	13.46	24.00	Cir	631.59	631.89	634.95	635.06	0.99	4.28
Line T-1	1.48	18.00	Cir	636.50	636.72	636.88	637.19	0.98	3.66
Line T-2	0.97	18.00	Cir	636.72	636.93	637.37	637.34	0.98	1.93
Line X-1	571.89	27 x 120	Box	627.80	628.34	633.50	633.50	1.00	11.21
Line X-2	540.29	48 x 120	Box	630.34	630.74	633.50	634.74	1.03	15.58
Line X-3	28.34	36.00	Cir	630.34	630.69	633.50	633.61	0.51	4.48
Line X-4	27.47	36.00	Cir	630.66	630.84	633.98	634.04	0.51	3.98
Line X-5	26.62	36.00	Cir	630.84	631.05	634.24	634.30	0.51	3.82
Line Y-1	3.62	18.00	Cir	632.67	633.66	633.50	634.56	1.00	4.83
Line Y-2	1.87	18.00	Cir	633.66	633.90	634.56	634.59	0.53	2.80
Line Z	29.16	30.00	Cir	629.26	629.60	634.86	635.21	0.50	5.94

- SPECIAL NOTES:  
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 3. SEE SHEETS C8.0 TO C8.5 FOR GRADING INFORMATION.  
 4. SEE SHEETS C9.0 TO C9.5 FOR STORM PIPE LAYOUT INFORMATION.  
 5. LINE W SHOULD BE DESIGNED FOR 3 - 6' OF COVER.

\* POND F PERMANENT POOL ELEVATION = 633.50 (FINAL DEVELOPMENT).  
 \*\* POND G PERMANENT POOL ELEVATION = 629.50 (FINAL DEVELOPMENT).

SCALE	1'x5' HORIZONTAL					
REV.	DATE	DRAWN	CHECKED	DESCRIPTION	PE	DRNAGE
BSJ			RAN		CON REVIEW	
					DATE: SEPTEMBER 15, 2011	

**C9.10**

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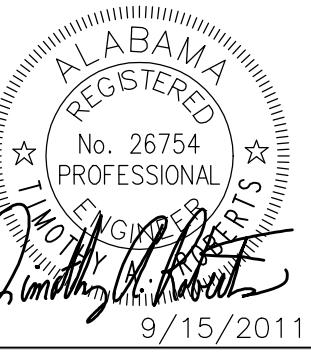


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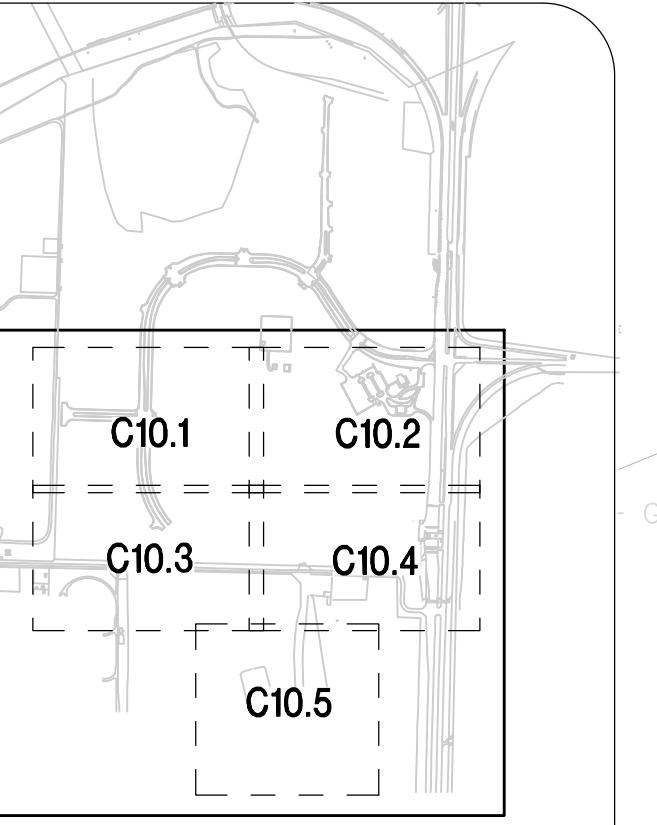
**HUNTSVILLE**  
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**EXISTING EROSION CONTROL PLAN - FOR REFERENCE ONLY**  
**REDSTONE GATEWAY - PACKAGE 1F**  
**ROADWAY IMPROVEMENTS**  
**CITY OF HUNTSVILLE**  
**HUNTSVILLE, ALABAMA**

REV.	DATE	DRAWN	CHECKED	DESCRIPTION	TRAFFIC	REAL	PE	DRAINAGE	COH. REVIEW
BSJ		RAN		DATE: SEPTEMBER 15, 2011					

**C10.0**


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**SITE KEY MAP**  
N.T.S.



- SPECIAL NOTES:**
- SEE SHEET C1.0 FOR ALL GENERAL NOTES.
  - SEE SHEET C1.0 IS REPRESENTATIVE OF ALL EROSION CONTROL MEASURES SCHEDULED TO BE INSTALLED IN PACKAGE 1A AND 1B. THE PACKAGE 1F CONTRACTOR SHALL MODIFY, REMOVE, AND INSTALL EROSION CONTROL MEASURES AS NECESSARY THROUGHOUT THE DURATION AND PHASING OF CONSTRUCTION AND AS A MINIMUM INSTAL PROPOSED MEASURES PER THE PROPOSED EROSION CONTROL PLANS (C10.1 THROUGH C10.5).
  - CONTRACTOR SHALL PLACE TOPSOIL, SEED, FERTILIZER, AND EROSION CONTROL BLANKETS (ECB) IMMEDIATELY UPON THE COMPLETION OF THE GRADING. ALL PERMANENT EROSION CONTROL MEASURES SHALL BE CLOSELY COORDINATED WITH THE LANDSCAPING PLANS (SEE SHEETS L1.1 THROUGH L1.4).
  - PLACE TOPSOIL, SEED AND EROSION BLANKET WHERE ECB IS DESIGNATED.
  - PACKAGE 1F CONTRACTOR IS RESPONSIBLE FOR PACKAGE 1A AND 1B BMP MEASURES AFFECTING THEIR WORK ONCE PACKAGE 1F CONTRACTOR HAS ACCEPTED AN AREA.
  - CONTRACTOR SHALL MAINTAIN AND REMOVE ANY EROSION CONTROL OR TEMPORARY CONSTRUCTION ITEMS (BY THE CONTRACTOR THAT INSTALLED THEM) ONCE THEY ARE ESTABLISHED OR NO LONGER REQUIRED. REFER TO PROJECT SPECIFICATIONS FOR WILDFLOWER MIX CRITERIA.
  - SEE EROSION CONTROL NOTES ON SHEET C1.0 FOR ALDOT AND WILDFLOWER SEEDING REQUIREMENTS.



0 75 150 SCALE 1 = 150 300

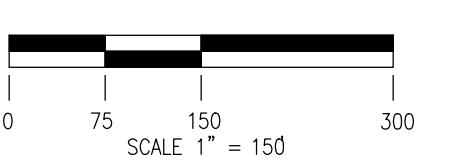

BOUNDARY




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HUNTSVILLE  
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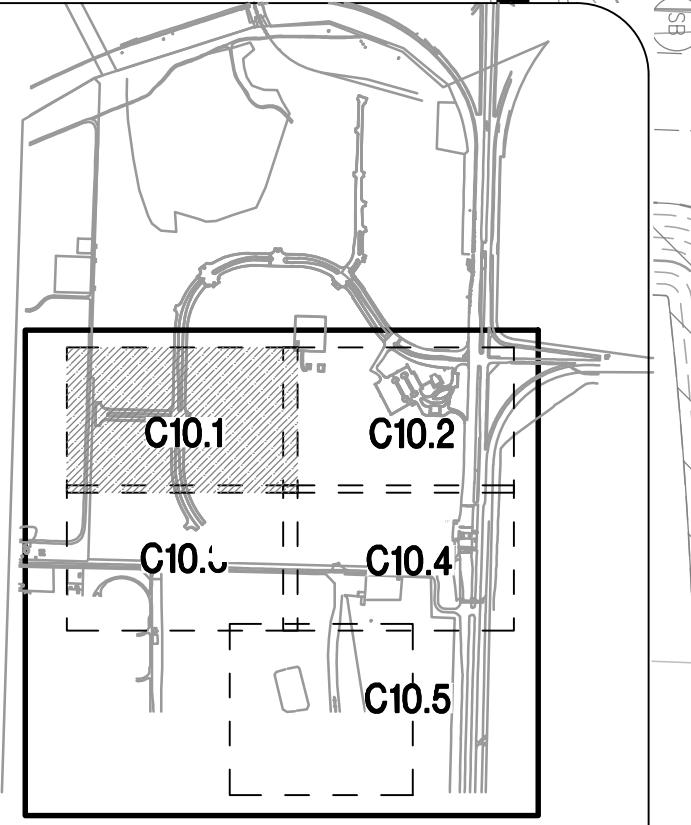
## EROSION CONTROL PLAN REDSTONE GATEWAY - PACKAGE 1F ROADWAY IMPROVEMENTS CITY OF HUNTSVILLE HUNTSVILLE, ALABAMA

REF.	DATE	DRAWN	CHECKED	DESCRIPTION	TRACED	RECALLED	PE	DRNAGE	CON. REVIEW
				RAN					SEPTEMBER 15, 2011




**C10.1**

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EROSION CONTROL LEGEND	
SB	SILT FENCING
WIP	WATTLE INLET PROTECTION
CDW	WATTLE CHECK DAM
Rd	RIP RAP CHECK DAM
LB	LOG & BRUSH
Fr	FILTER RING
FL	FLOC LOG
CEP	CONSTRUCTION EXIT PAD
OP	OUTLET PROTECTION
FBS	FORE BAY SPILLWAY
TG	TOPSOIL
CBB	EROSION CONTROL BLANKET
DV	DIVERSION BERM
PS	PERMANENT SEEDING (COORDINATE WITH LANDSCAPING PLANS)
TS	TEMPORARY SEEDING
SDG	SODDING (COORDINATE WITH LANDSCAPING PLANS)
MU	MULCHING
Su	SURFACE ROUGHENING
PB	FORE BAY
RS	RIP RAP LINED SWALE

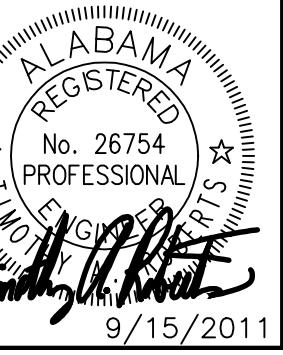

**SITE KEY MAP**  
N.T.S.

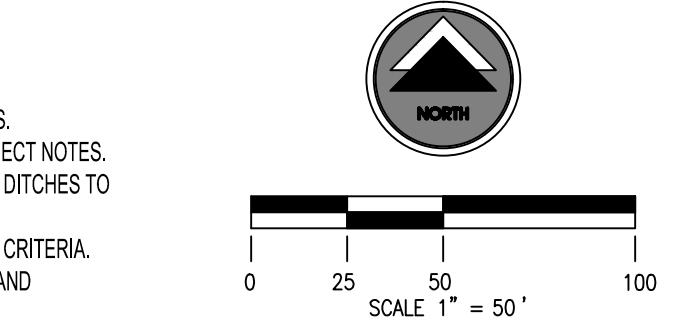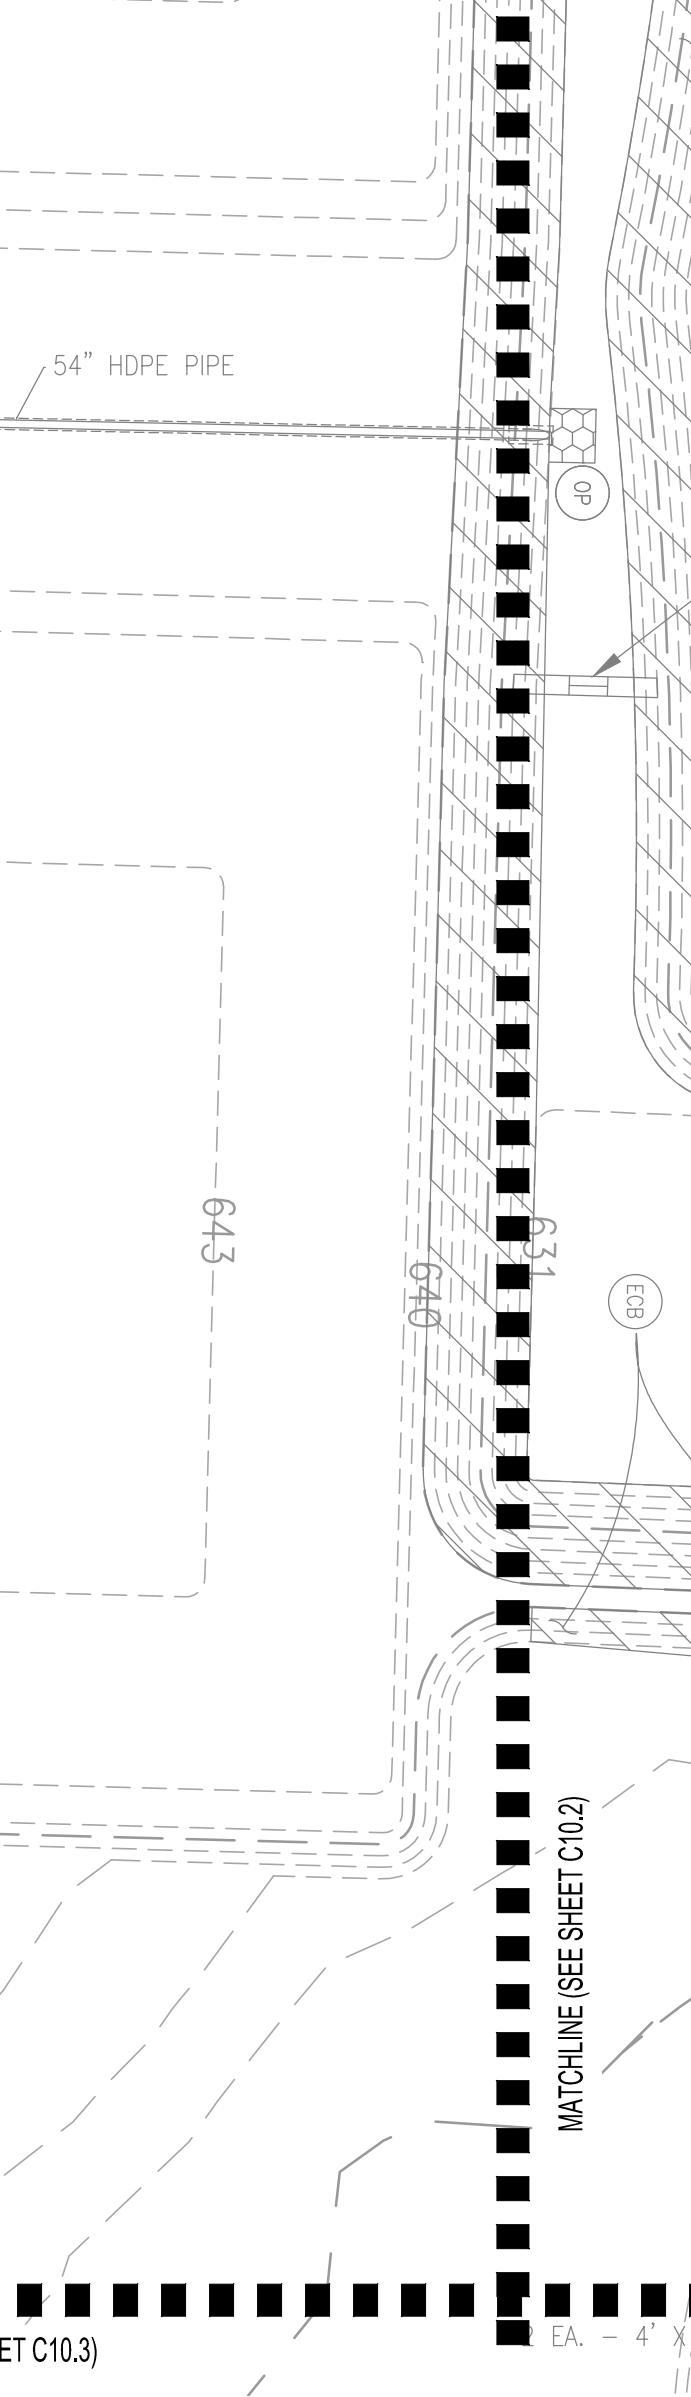
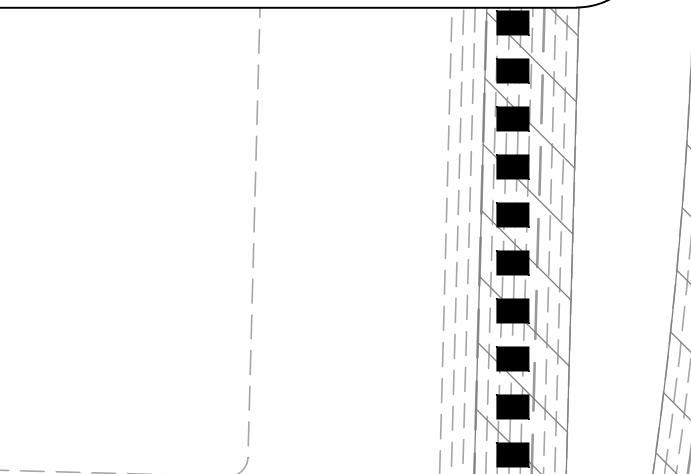


MATCHLINE (SEE SHEET C10.3)

MATCHLINE (SEE SHEET C10.2)




SPECIAL NOTES:  
 1. SEE SHEET C1.0 FOR APPLICABLE PROJECT GENERAL NOTES.  
 2. SEE SHEET C1.0 FOR ADDITIONAL EROSION CONTROL PROJECT NOTES.  
 3. EXISTING EROSION CONTROL BLANKET AND OTHER BMPs IN DITCHES TO BE FILLED SHALL BE REMOVED PRIOR TO FILLING DITCH.  
 4. REFER TO PROJECT SPECIFICATIONS FOR WILDFLOWER MIX CRITERIA.  
 SEE EROSION CONTROL NOTES ON SHEET C1.0 FOR ALDOT AND  
 WILDFLOWER SEEDING REQUIREMENTS.

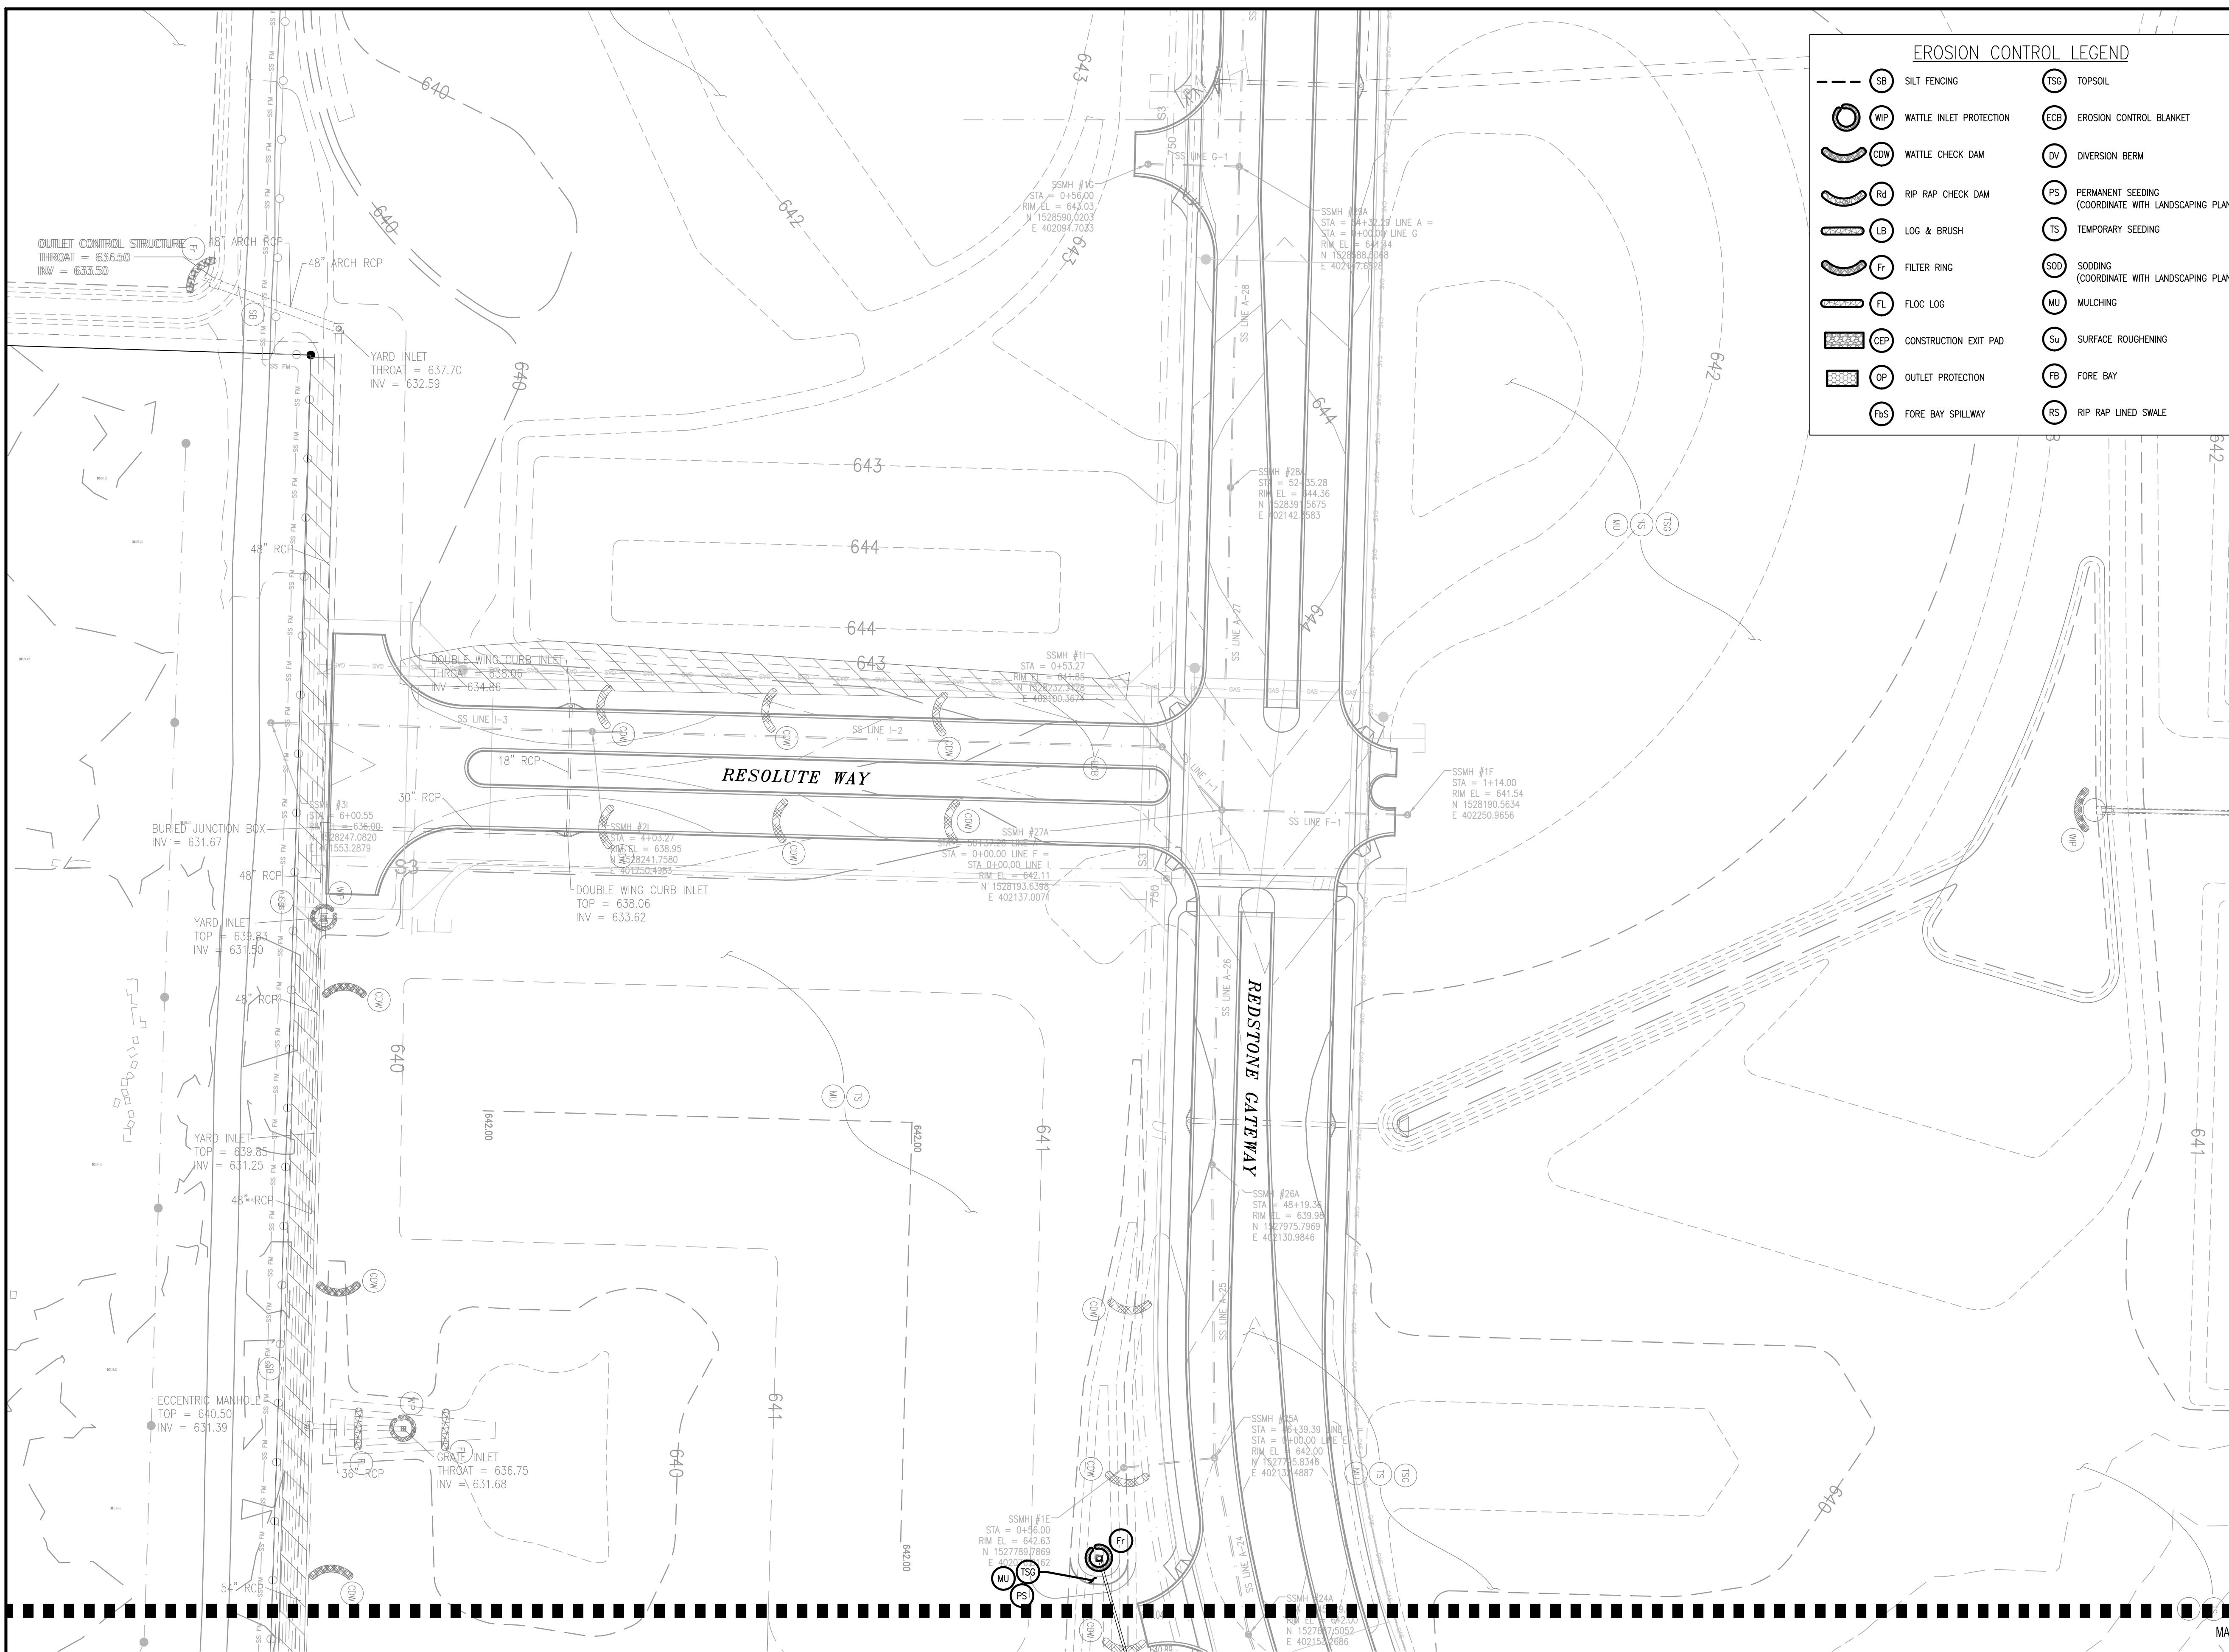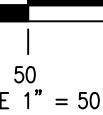





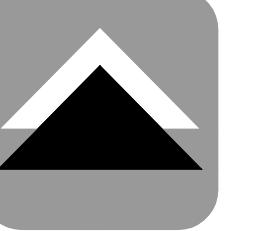


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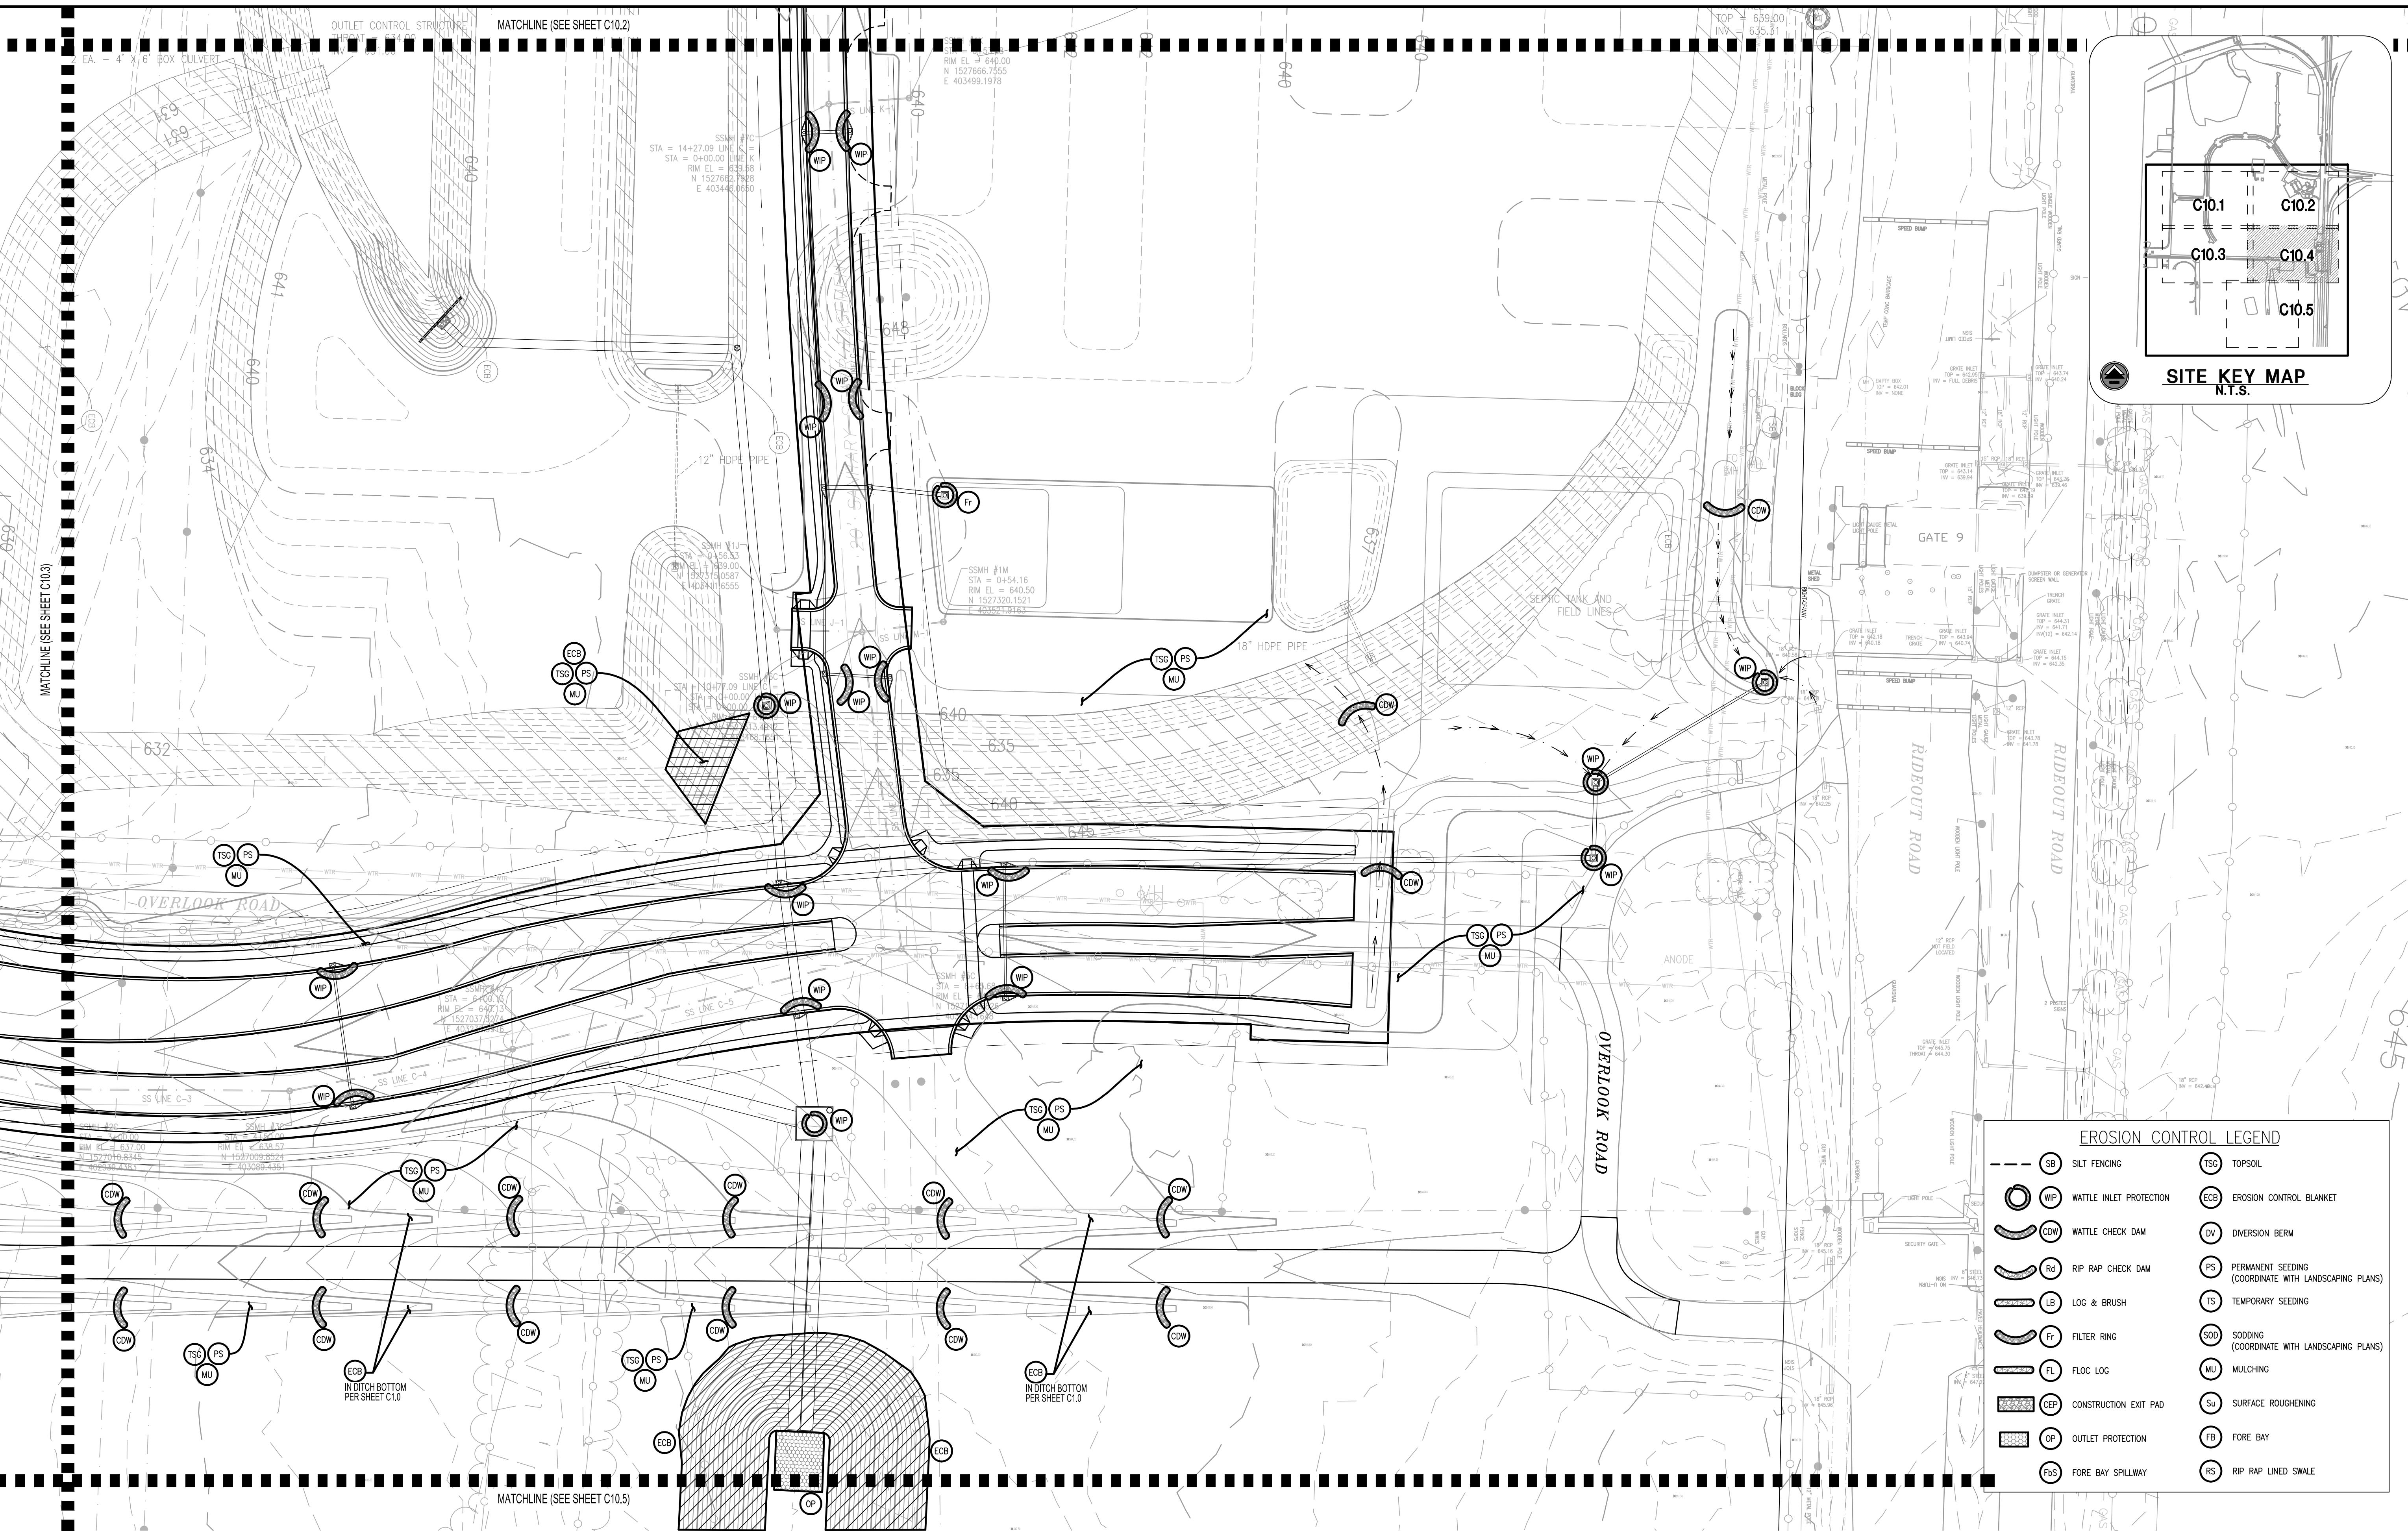
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## EROSION CONTROL PLAN REDSTONE GATEWAY - PACKAGE 1F ROADWAY IMPROVEMENTS CITY OF HUNTSVILLE HUNTSVILLE, ALABAMA


REF.	DATE	DRAWN	CHECKED	DESCRIPTION	PE	DRAINAGE	TRAVEL	REAL	PER	CON	REVIEW
											SEPTEMBER 15, 2011

**C10.4**

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- SPECIAL NOTES:
- SEE SHEET C1.0 FOR APPLICABLE PROJECT GENERAL NOTES.
  - SEE SHEET C10.0 FOR ADDITIONAL EROSION CONTROL PROJECT NOTES.
  - EXISTING EROSION CONTROL BLANKET AND OTHER BUMPS IN DITCHES TO BE FILLED SHALL BE REMOVED PRIOR TO FILLING DITCH.
  - REFER TO PROJECT SPECIFICATIONS FOR WILDFLOWER MIX CRITERIA.
  - SEE EROSION CONTROL NOTES ON SHEET C1.0 FOR ALDOT AND WILDFLOWER SEEDING REQUIREMENTS.

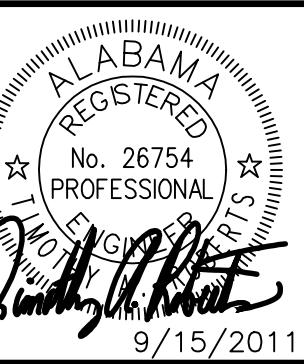

0 25 50 SCALE 1" = 50'

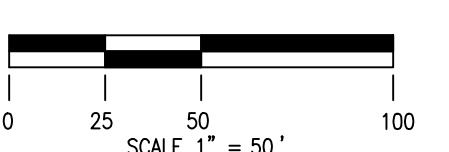